# THE BEEHIVE - KEY WORKER HOUSING, FRENCHS FOREST HOSPITAL

Boarding House 16 Gladys Avenue, Frenchs Forest

### **DRAWING LIST**

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#### ARCHITECTURAL DESIGN STATEMENT

This design statement has been prepared by BKA on behalf of Williamson Building Corporation for the purpose of a DA Boarding House submission at 16 Gladys Avenue, Frenchs Forest. The intent of this design is to create a contextually appropriate development, through sensible architecture design that carefully articulates the building volumes with materiality, rhythm and proportion in harmony with the adjacent context.

The site is located midway along a guiet cul-de-sac road and it is bounded by battle-axe blocks of 16a & 16b Gladys Ave. This creates an 'island' effect on this large site, being it bounded by driveways or roads in almost all sides. There is a considerable change in level downwards from the street towards the north of the site, which makes it ideal to take advantage of long-distance views over the valley and favourable northern aspect with minimum overshadowing towards neighbouring properties. The site is within short walking distance of major transport routes and the newly opened Northern Beaches Hospital, an important piece of infrastructure that came in to completely change the needs and characteristics of this area.

The architecture proposed recognises that boarding housing, notwithstanding is a permissible use for the block, is a relatively new form within the immediate context, which is merely two and three storey large single dwelling residential. Hence, the buildings comprising the development are domestic in their form and scale. Addressing Gladys Avenue, it is proposed a two-storey element, with a single driveway, an ample balcony and articulated facades that fits perfectly within the residential streetscape. Large trees in the front setback have been retained and protected, and the existing front solid boundary wall has been removed to further naturally integrate the site with the adjacent densely planted context.

The remaining of the building volumes are distributed along the site following the steep topography. They present a two-story base with a recessed third story level to emphasise its domestic scale. The northern volumes are oriented to maximise solar access and take advantage of the splendid long-distance views. The side elevations of northern volumes are technically 'articulated blind walls' to minimise any overlooking into adjacent properties on 14 & 18 Gladys Avenue. They are setback 2m from side boundaries to allow for deep soil screening planting. The larger than 6m rear setback allows for lush planting and further screening of the proposal from 16a & 16b Gladys Ave dwellings.

The southern volumes are oriented east-west and incorporate large 6m side setbacks which, plus adding the battle-axe driveways, achieve more than adequate privacy from adjacent dwellings. Northern and southern volumes are separated by a couple of large courtyards, breaking the bulk and scale of the development and producing introvert communal areas, away from the side boundaries. These deep soil courtyards also allow for large tree planting within the development.

All ground floor units enjoy access to private terraces for greater amenity. These terraces are screened from neighbours and adjacent rooms by traditional timber screens and planting. Upper level units enjoy 'Juliet balconies' which allow for floor to ceiling glazing without compromising privacy. A Communal Rooftop Terrace is provided above northern buildings, offering amazing long-distance views to the residents.

The rooms proposed are the so called 'New Generation' boarding rooms, with self-contained private bathrooms and kitchenettes, targeting professional and working occupants, to satisfy the sudden demand created by the newly opened Northern Beaches Hospital.


Secure vehicular car parking is provided in a basement level, completely screened from the street. The number of car parking provided exceeds the minimum requirements by the DCP and allows for additional features like visitors parking or car sharing arrangements. Compliant motorcycle and bicycle are also securely provided within basement. Nevertheless, the site is located just a few meters away from major sources of employment like the new Hospital, Schools and the Business Park, and major public transport routes.


The materials selected, sand stone, reconstituted timber and exposed concrete, are noble and timeless in nature. They are consistent with contemporary residential developments along the Northern Beaches and ensure low maintenance and long-lasting appearance. The carefully designed landscape comprises low maintenance shrubs and grasses, as well as native and exotic species.

In summary the proposed Boarding House is a contemporary piece of architecture which uses traditional materials and techniques to create a visually exciting, yet respectful addition to the area. The development will provide great amenity for its residents and convenient accommodation for key workers of the newly opened Northern Beaches Hospital. The site is a prime location for the boarding house typology.

TOWN PLANNER <b>DMPS -</b> Daniel McNamara +61 409 990 464 E daniel@dmps.com.au	TRAFFIC ENGINEER <b>TEF CONSULTING</b> - Oleg Sannikov +61 2 9332 2024 E o.s@tefconsult.com.au	
SECTION J EFFICIENT LIVING - Olivia Shortall	LANDSCAPE ARCHITECT MCLEAN DESIGN - Darrell McLean	FOR DA PURPOSE
+61 2 9970 6181 E olivia@efficientliving.com.au	+61 408 074 967 E df8mclean@gmail.com	NOT FOR CONSTRUCTIO
CIVIL ENGINEER MARTENS & ASSOCIATES - Gray Taylor +61 2 9476 9999 E gtaylor@martens.com.au	ACOUSTICS NG CHILD & ASSOCIATES - Noel Child +61 2 9899 1968 E ngchild@canda.com	



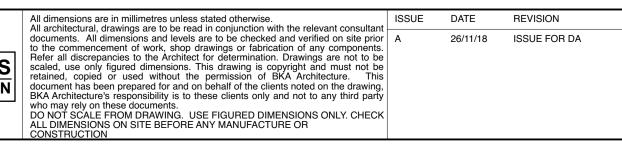

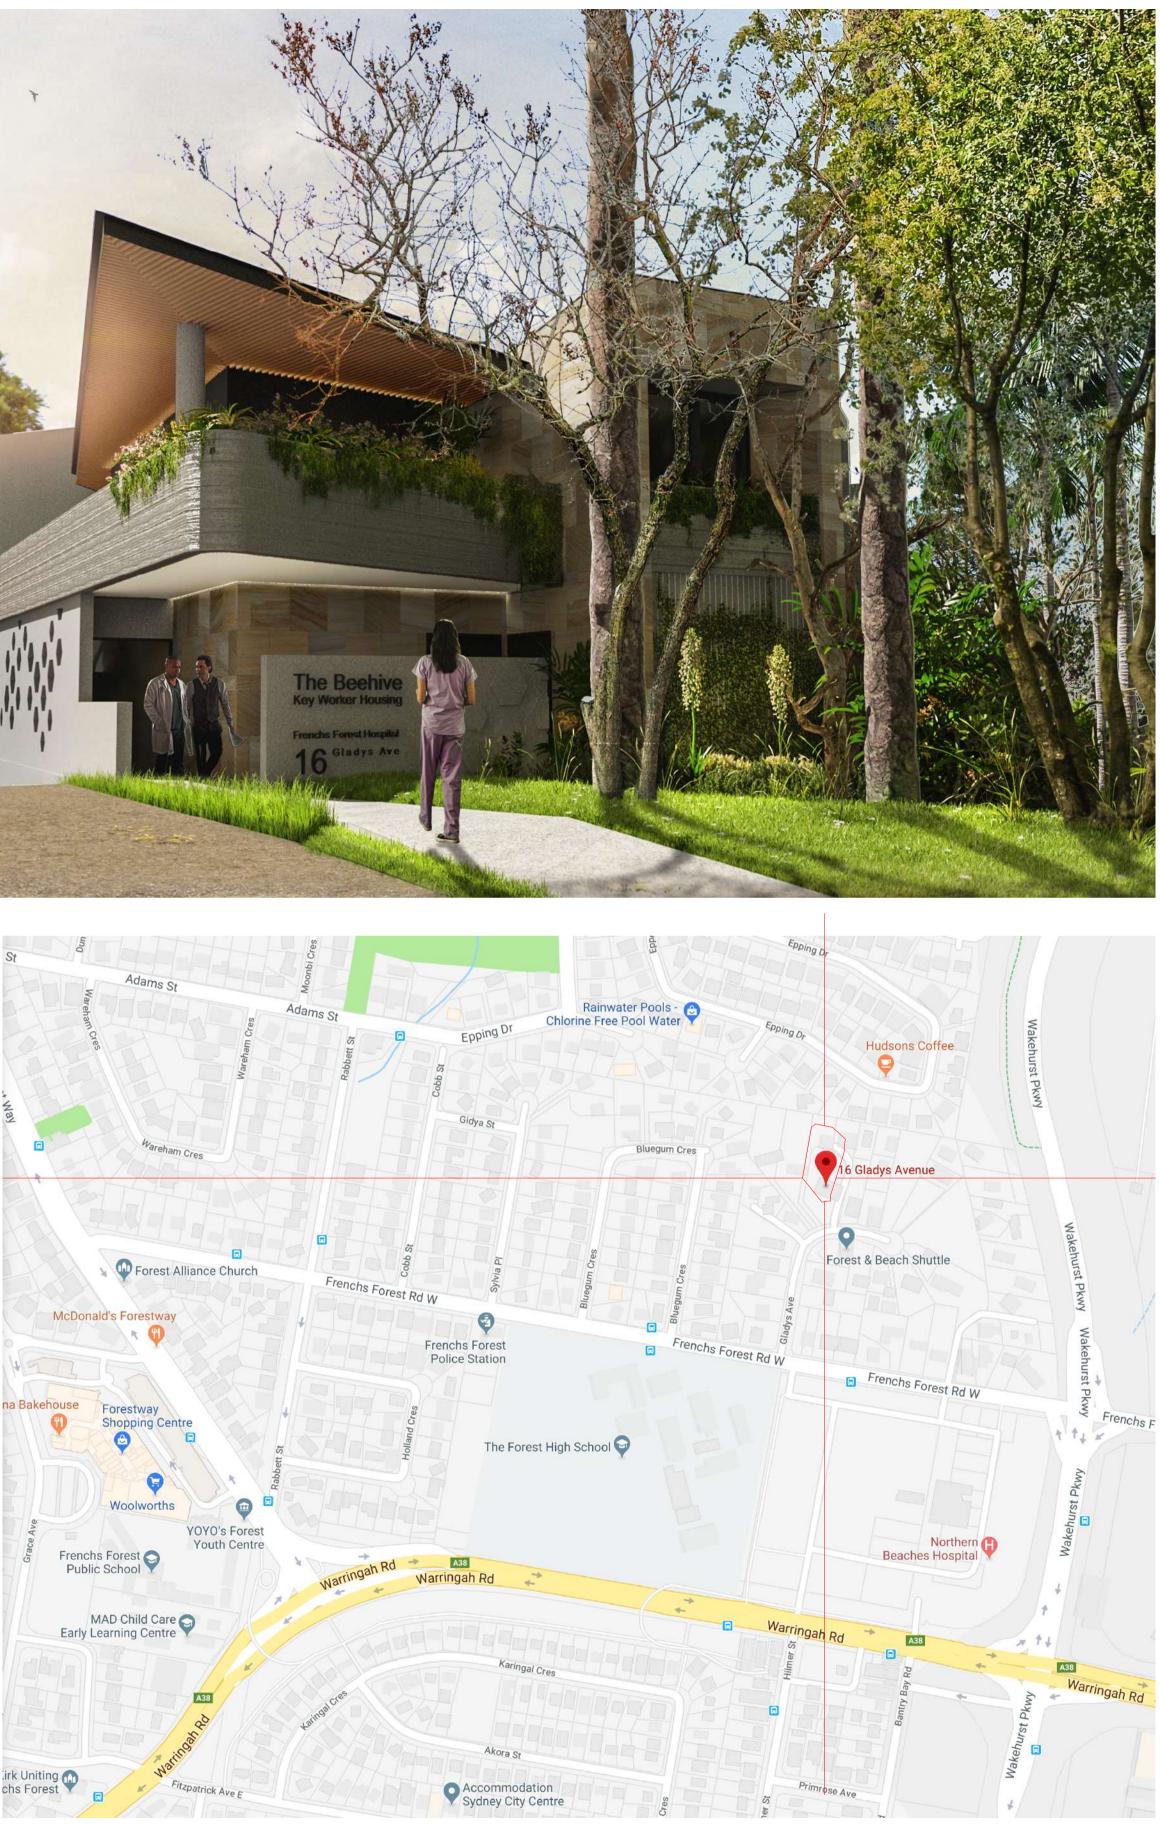

LOCATION PLAN n.t.s



		PROJECT DEVELOPMENT APPLICATION	PROJECT #	18065	SCALE @ A1	NTS
arch	nitecture		DRAWN	LS	CHECKED	JK
	BYRON BAY Unit 1	ADDRESS 16 GLADYS AVENUE FRENCHS FOREST	DATE	6/12/18	DRAWING No.	
St, e 0	10 Station St, Bangalow NSW 2479	CLIENT WILLIAMSON BUILDING CORPORATION	NORTH	$\bigcirc$	<b>DA-000</b>	
26 5563	<b>T</b> : +61 2 4926 5563	DRAWING Cover Page			REV	A

### **GFA and FSR Controls**

Site Area:

2411

sqm

Level	Proposed GFA (sqm)	Control
Lower Floor Plan	291.69	
Ground Floor Plan _ Upper & Lower	859.06	
Level 1 Floor Plan _ Upper & Lower	804.86	
Level 2 Floor Plan _ Upper & Lower	445.48	
Total GFA	2401.09	
Total FSR	0.9959	

### Landscape and Deep Soil Controls

Control	Proposed	%
Landscaped Area - 40%	1068.81	44.3
Deep Soil - 40%	987.24	40.9

Parking Controls		
Control	Required	Proposed
Parking	16*	21
Motorcycle Parking Provided:	-	17
Bicycle Parking Provided:	11*	17
* as par DCD Defar to traffic appringer	Kapart	

\* as per DCP. Refer to traffic engineer report


Building Inclusions		
Area	Quantity	Area (sq.m)
Accessible Boarding Rooms	5	>12sqm + Wet Areas
Double Boarding Rooms	76	>16sqm + Wet Areas
House Manager Room	1	36.14sqm + 8.43sq.m office + 19.06 sqm POS
Total Boarding Rooms:	82	
Total Communal Areas (sqm):	2	45.53
Communal Living Area	1	26.88
Communal Laundry	1	18.65
Total Communal Open Space (sqm):	2	125.2
Communal Courtyard	1	78.14
Communal Roof Top Terrace	1	47.06





EGEND	)	TOWN PLANNER	TRAFFIC ENGINEER	
	DEEP SOIL PLANTING AREA	DMPS - Daniel McNamara +61 409 990 464 E daniel@dmps.com.au	TEF CONSULTING - Oleg Sannikov           +61 2 9332 2024         E o.s@tefconsult.com.au	
	PLANTING ON SLAB AREA	SECTION J	LANDSCAPE ARCHITECT	FOR DA PURPOSES
	GFAAREA	EFFICIENT LIVING - Olivia Shortall	MCLEAN DESIGN - Darrell McLean	FUR DA FURFUSES
		+61 2 9970 6181 E olivia@efficientliving.com.au	+61 408 074 967 E df8mclean@gmail.com	NOT FOR CONSTRUCTION
		CIVIL ENGINEER MARTENS & ASSOCIATES - Gray Taylor +61 2 9476 9999 E gtaylor@martens.com.au	ACOUSTICS NG CHILD & ASSOCIATES - Noel Child +61 2 9899 1968 E ngchild@canda.com	



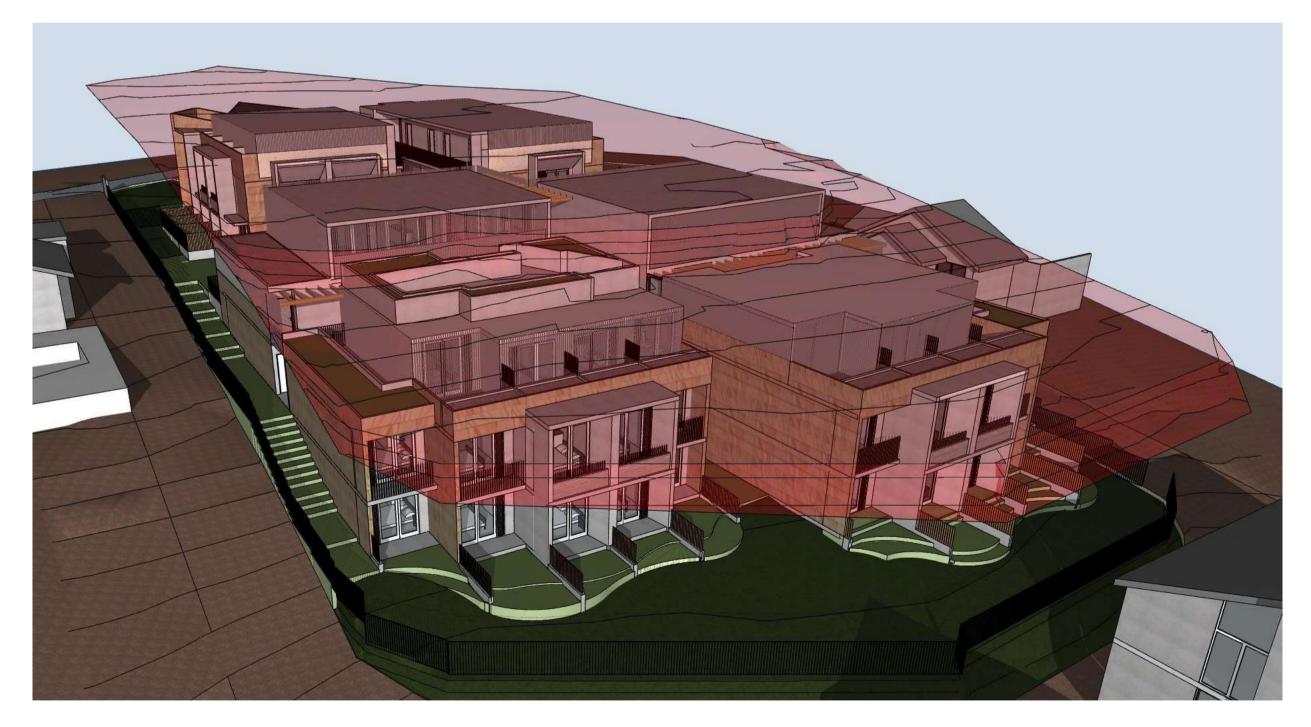

3D view with 8.5m height plane shown in red (5

PROPOSAL COMPLIES ENTIRELY WITH 8.5m MAX HEIGHT LIMIT AS PER LEP



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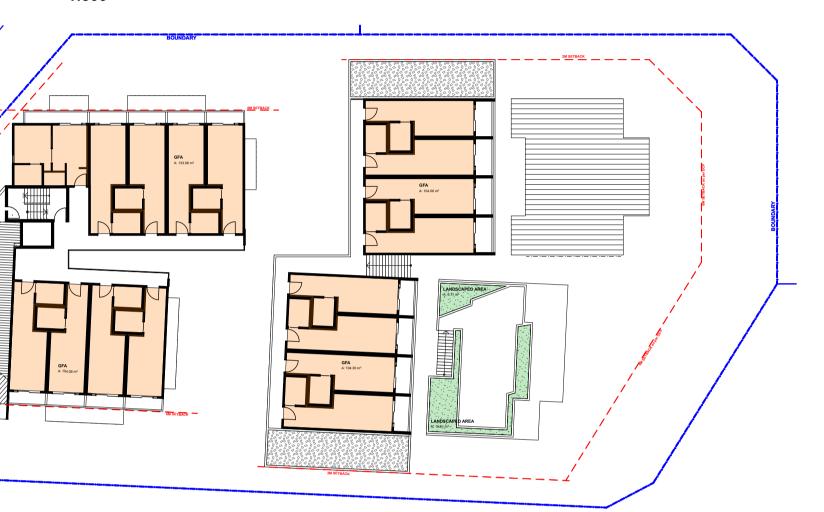
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### 1st Floor\_Upper & Lower 1:300


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### 2nd Floor\_Upper & Lower 1:300

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oro	bitaatura	PROJECT DEVELOPMENT APPLICATION	PROJECT #	18065	SCALE @ A1	1:300
arc	hitecture		DRAWN	LS	CHECKED	JK
ASTLE	BYRON BAY Unit 1	ADDRESS 16 GLADYS AVENUE FRENCHS FOREST	DATE	6/12/18	DRAWING No.	
St, e 0	10 Station St, Bangalow NSW 2479	CLIENT WILLIAMSON BUILDING CORPORATION	NORTH	$\square$	DA-00'	
26 5563	<b>T</b> : +61 2 4926 5563	DRAWING Calculations		$\square$	REV	A






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arc	hitecture		DRAWN	LS	CHECKED	JK
ASTLE	BYRON BAY Unit 1	ADDRESS 16 GLADYS AVENUE FRENCHS FOREST	DATE	6/12/18	DRAWING No.	
n St, e )0	10 Station St, Bangalow NSW 2479	CLIENT WILLIAMSON BUILDING CORPORATION	NORTH	$\square$	<b>DA-00</b>	4
926 5563	<b>T</b> : +61 2 4926 5563	DRAWING Site Plan/ Site analysis		$\square$	REV	A

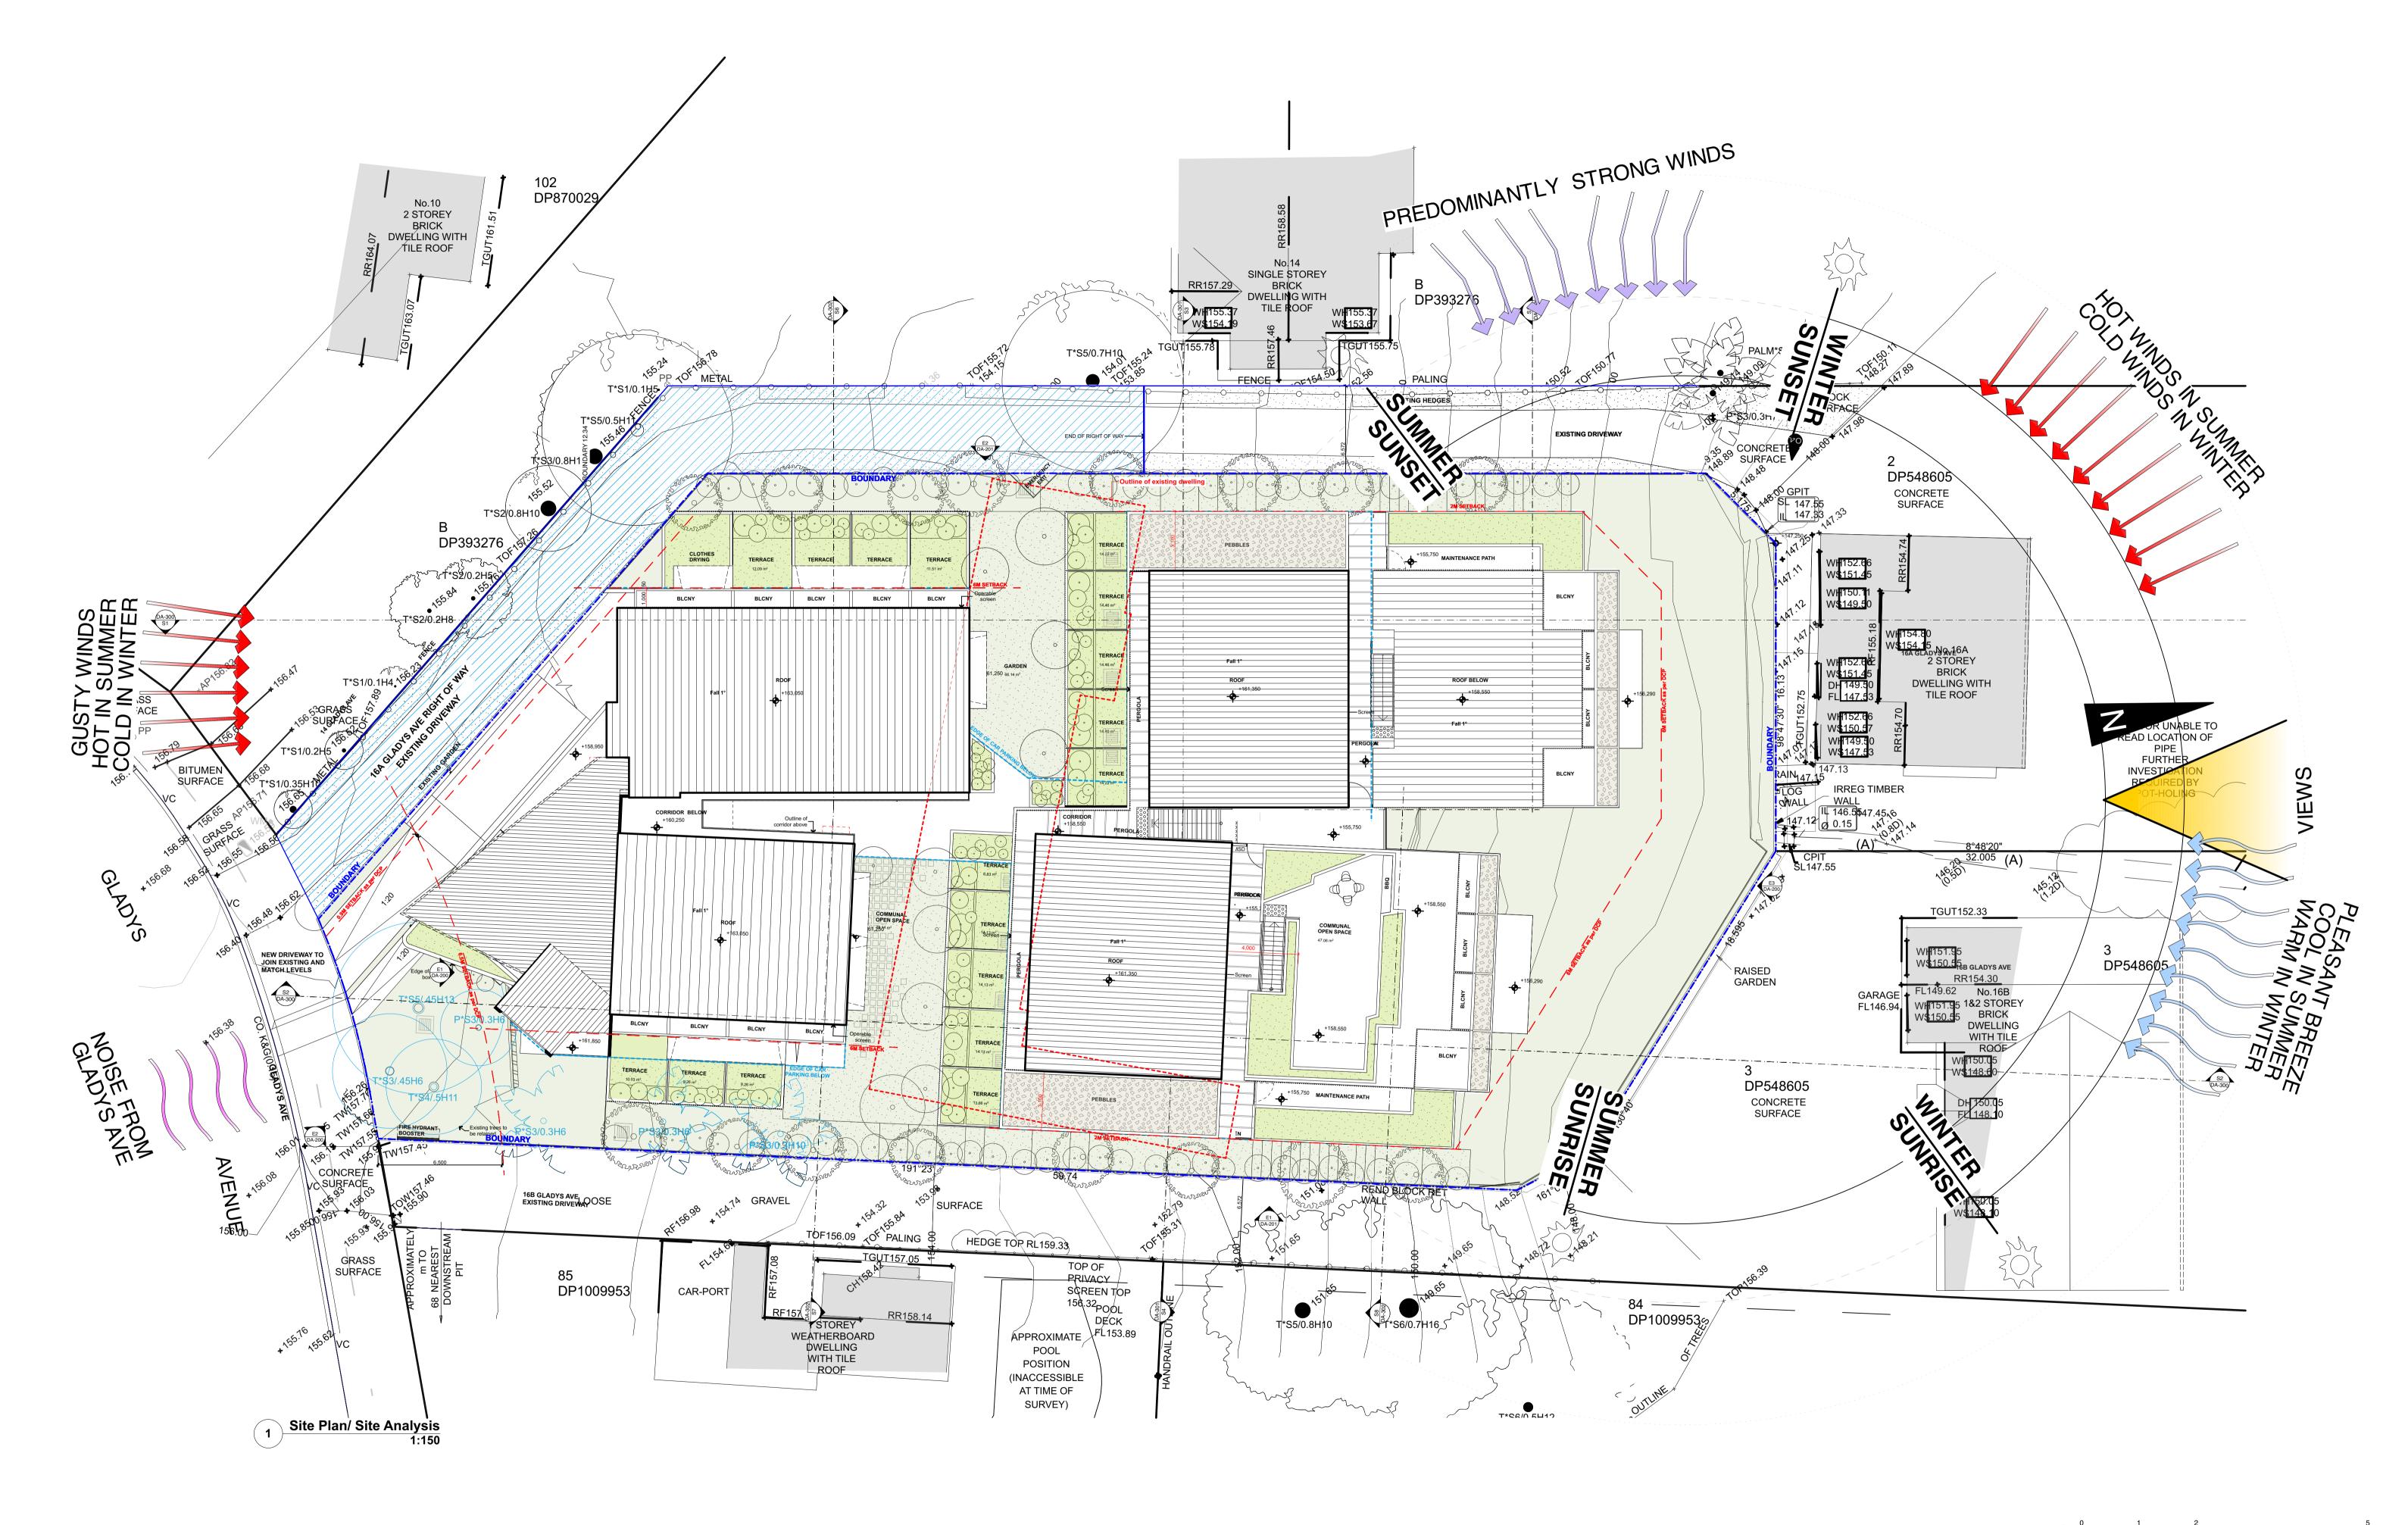

	$\left( \cdot \right)$	Existing trees to be retained	Private terraces	+61 409 990 464 E daniel@dmps.com.au	+61 2 9332 2024 E o.s@tefconsult.com.au	
-		Setback line	Communal laundry/ services	SECTION J EFFICIENT LIVING - Olivia Shortall	LANDSCAPE ARCHITECT MCLEAN DESIGN - Darrell McLean	FOR DA PURPOSE
		Boundary line	Communal living room	+61 2 9970 6181 E olivia@efficientliving.com.au	+61 408 074 967 E df8mclean@gmail.com	NOT FOR CONSTRUCTION
-		Existing fence line	Adaptable/ Single lodger unit	CIVIL ENGINEER MARTENS & ASSOCIATES - Gray Taylor	ACOUSTICS NG CHILD & ASSOCIATES - Noel Child	
	MSD	Magnetic Smoke Door	Double lodger unit	+61 2 9476 9999 E gtaylor@martens.com.au	+61 2 9899 1968 E ngchild@canda.com	

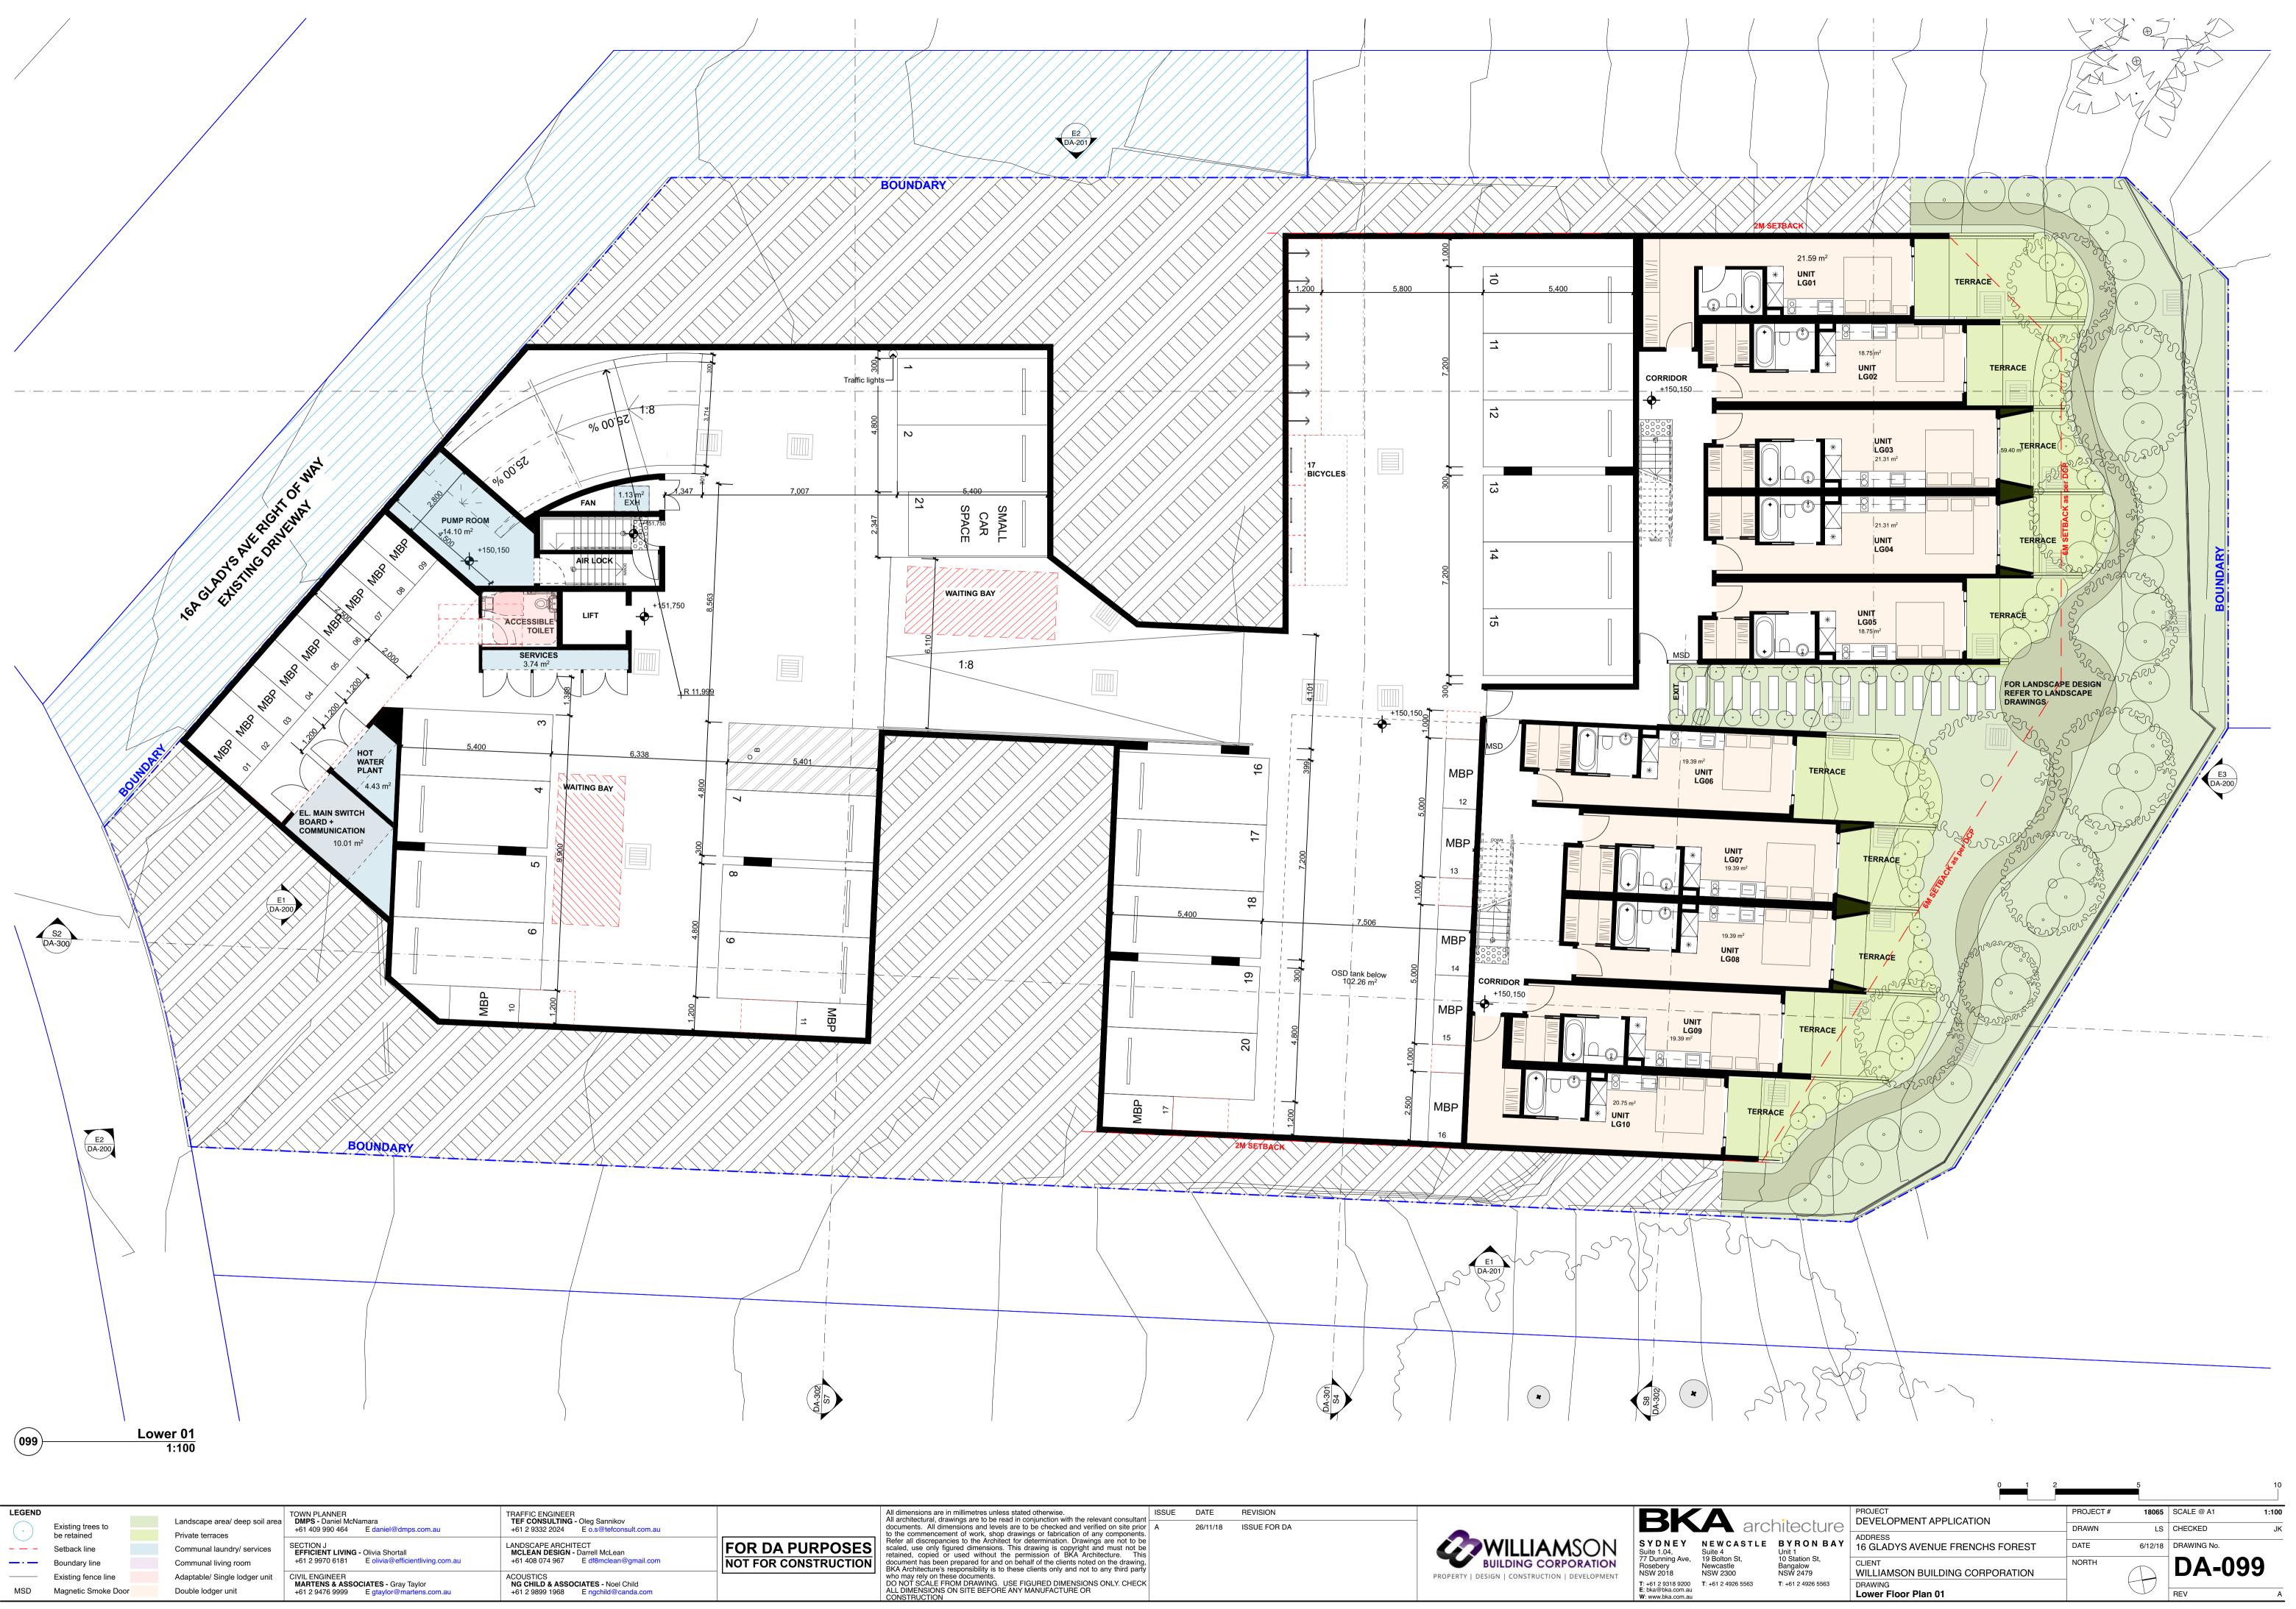

		PROJECT	PROJECT #	18065	SCALE @ A1	1:100
arc	hitecture	DEVELOPMENT APPLICATION	DRAWN	LS	CHECKED	JK
ASTLE	BYRON BAY Unit 1	ADDRESS 16 GLADYS AVENUE FRENCHS FOREST	DATE	6/12/18	DRAWING No.	
St, )	10 Station St, Bangalow NSW 2479	CLIENT WILLIAMSON BUILDING CORPORATION	NORTH	$\square$	DA-09	<b>99</b>
6 5563	<b>T</b> : +61 2 4926 5563	DRAWING Lower Floor Plan 01		$\Box$	REV	A




LEGEND			TOWN PLANNER	TRAFFIC ENGINEER	
$\overline{(\cdot)}$	Existing trees to	Landscape area/ deep soil area	DMPS - Daniel McNamara +61 409 990 464 E daniel@dmps.com.au	TEF CONSULTING - Oleg Sannikov           +61 2 9332 2024         E o.s@tefconsult.com.au	
$\bigcirc$	be retained	Private courtyards			
	Setback line	Communal laundry	SECTION J EFFICIENT LIVING - Olivia Shortall	LANDSCAPE ARCHITECT MCLEAN DESIGN - Darrell McLean	FOR DA PURPOSE
<u> </u>	Boundary line	Communal living room	+61 2 9970 6181 E olivia@efficientliving.com.au	+61 408 074 967 E df8mclean@gmail.com	NOT FOR CONSTRUCTIO
	Existing fence line	Adaptable/ Single lodger unit	CIVIL ENGINEER MARTENS & ASSOCIATES - Gray Taylor	ACOUSTICS NG CHILD & ASSOCIATES - Noel Child	
MSD	Magnetic Smoke Door	Double lodger unit	+61 2 9476 9999 E gtaylor@martens.com.au	+61 2 9899 1968 E ngchild@canda.com	

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		PROJECT DEVELOPMENT APPLICATION		PRO	JECT #	18065	SCALE @ A1	1:100
arc	hitecture			DRA	WN	LS	CHECKED	JK
ASTLE	BYRON BAY Unit 1	ADDRESS 16 GLADYS AVENUE FRENCHS	FOREST	DATE	E	6/12/18	DRAWING No.	
St, 10 Station St, Bangalow 0 NSW 2479		CLIENT WILLIAMSON BUILDING CORPO	ORATION	NOR	тн (	$\square$	<b>DA-1</b>	00
26 5563	<b>T</b> : +61 2 4926 5563	DRAWING Ground Floor Plan _ Upper&Lo	wer		t	D	REV	A




	Existing trees to be retained	Landscape area/ deep soil area Private courtyards	TOWN PLANNER <b>DMPS -</b> Daniel McNamara +61 409 990 464 E daniel@dmps.com.au	TRAFFIC ENGINEER <b>TEF CONSULTING -</b> Oleg Sannikov +61 2 9332 2024 E o.s@tefconsult.com.au	
	Setback line	Communal laundry	SECTION J EFFICIENT LIVING - Olivia Shortall	LANDSCAPE ARCHITECT MCLEAN DESIGN - Darrell McLean	FOR DA PURPOSE
<u> </u>	Boundary line	Communal living room	+61 2 9970 6181 E olivia@efficientliving.com.au	+61 408 074 967 E df8mclean@gmail.com	NOT FOR CONSTRUCTIO
	Existing fence line	Adaptable/ Single lodger unit	CIVIL ENGINEER MARTENS & ASSOCIATES - Gray Taylor	ACOUSTICS NG CHILD & ASSOCIATES - Noel Child	
MSD	Magnetic Smoke Door	Double lodger unit	+61 2 9476 9999 E gtaylor@martens.com.au	+61 2 9899 1968 E ngchild@canda.com	

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RK		hitecture	PROJECT DEVELOPMENT APPLICATION	PROJECT #	18065	SCALE @ A1	1:100
	arc	hitecture		DRAWN	LS	CHECKED	JK
SYDNEY Suite 1.04,	NEWCASTLE Suite 4	BYRON BAY Unit 1	ADDRESS 16 GLADYS AVENUE FRENCHS FOREST	DATE	6/12/18	DRAWING No.	
77 Dunning Ave, Rosebery NSW 2018	19 Bolton St, Newcastle NSW 2300	10 Station St, Bangalow NSW 2479	CLIENT WILLIAMSON BUILDING CORPORATION	NORTH	$\square$	<b>DA-1</b>	)1
T: +61 2 9318 9200 E: bka@bka.com.au W: www.bka.com.au	<b>T</b> : +61 2 4926 5563	<b>T</b> : +61 2 4926 5563	DRAWING Level 01 Floor Plan _ Upper&Lower		$\square$	REV	A

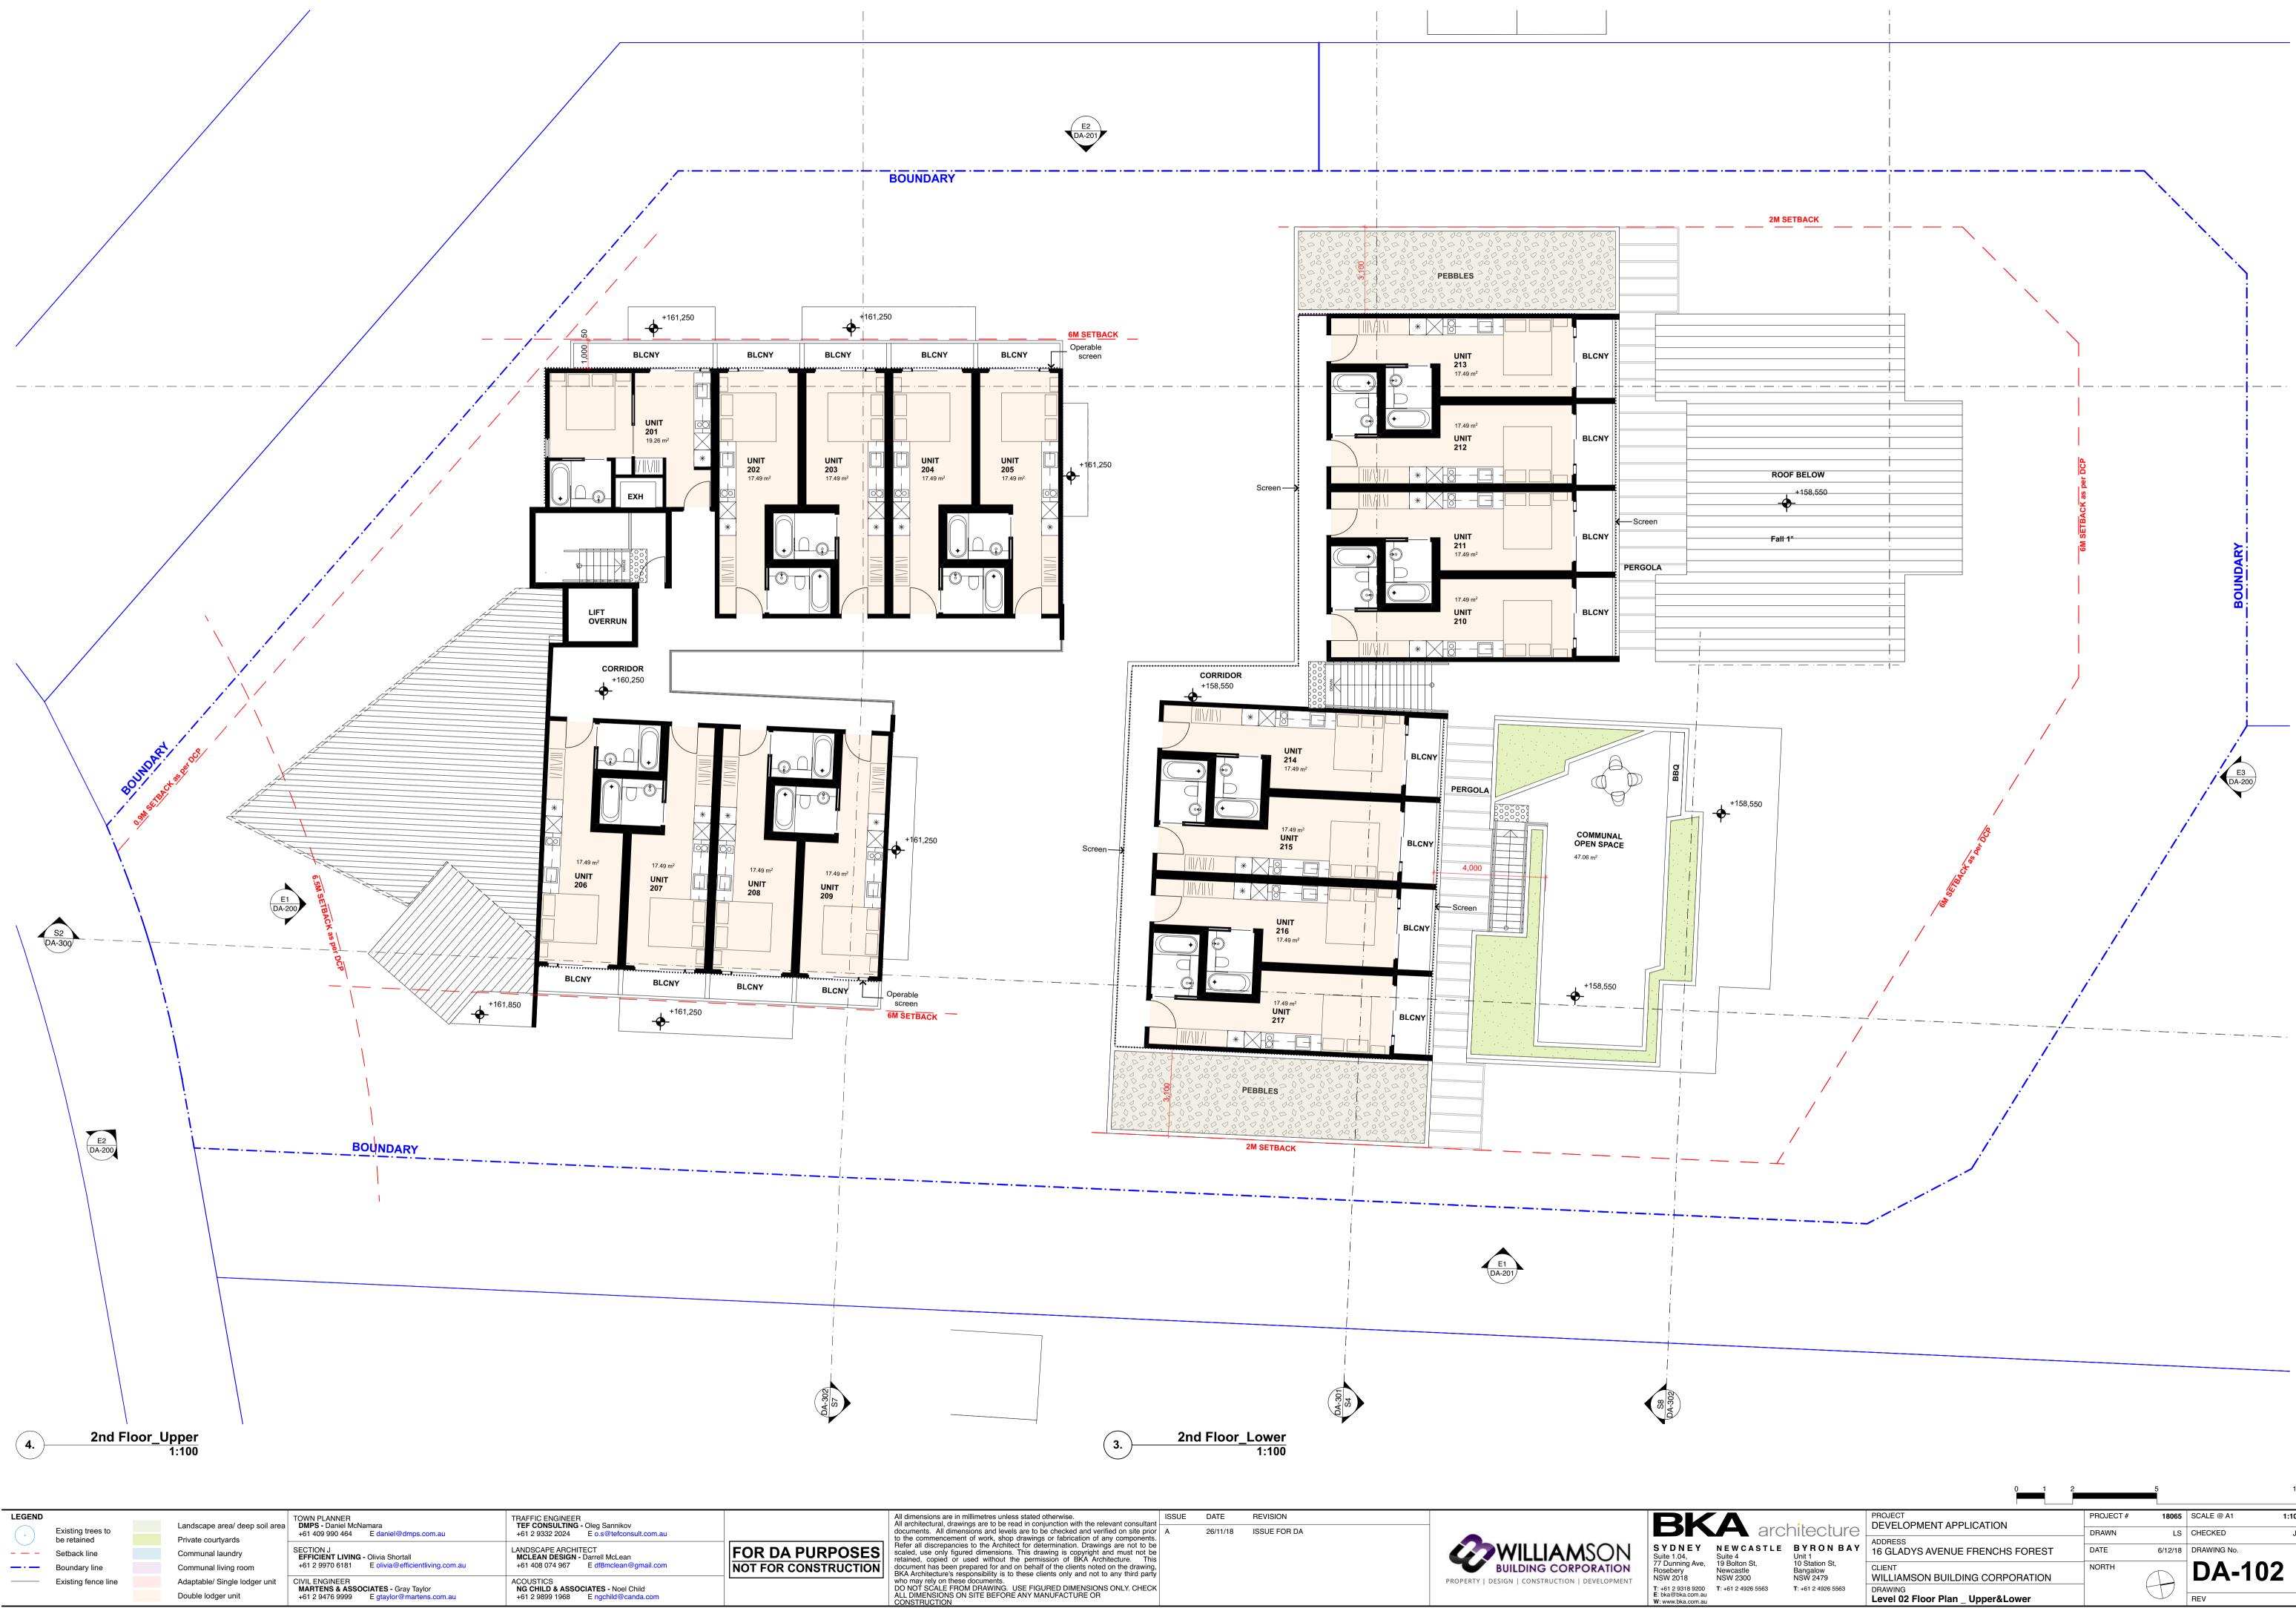


LEGEND			TOWN PLANNER	TRAFFIC ENGINEER	
	Existing trees to be retained	Landscape area/ deep soil area Private courtyards	DMPS - Daniel McNamara +61 409 990 464 E daniel@dmps.com.au	TEF CONSULTING - Oleg Sannikov         +61 2 9332 2024       E o.s@tefconsult.com.au	
	Setback line	Communal laundry	SECTION J EFFICIENT LIVING - Olivia Shortall	LANDSCAPE ARCHITECT MCLEAN DESIGN - Darrell McLean	FOR DA PURPOSE
<u> </u>	Boundary line	Communal living room	+61 2 9970 6181 E olivia@efficientliving.com.au	+61 408 074 967 E df8mclean@gmail.com	NOT FOR CONSTRUCTIO
	Existing fence line	Adaptable/ Single lodger unit	CIVIL ENGINEER MARTENS & ASSOCIATES - Gray Taylor	ACOUSTICS NG CHILD & ASSOCIATES - Noel Child	<b></b>
		Double lodger unit	+61 2 9476 9999 E gtaylor@martens.com.au	+61 2 9899 1968 E ngchild@canda.com	

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		PROJECT DEVELOPMENT APPLICATION	PROJECT #	18065	SCALE @ A1 1	:100
arci	hitecture		DRAWN	LS	CHECKED	JK
ASTLE	BYRON BAY Unit 1	ADDRESS 16 GLADYS AVENUE FRENCHS FOREST	DATE	6/12/18	DRAWING No.	
St, e 0	10 Station St, Bangalow NSW 2479	CLIENT WILLIAMSON BUILDING CORPORATION	NORTH	$\square$	<b>DA-102</b>	
26 5563	<b>T</b> : +61 2 4926 5563	DRAWING Level 02 Floor Plan _ Upper&Lower		D	REV	A

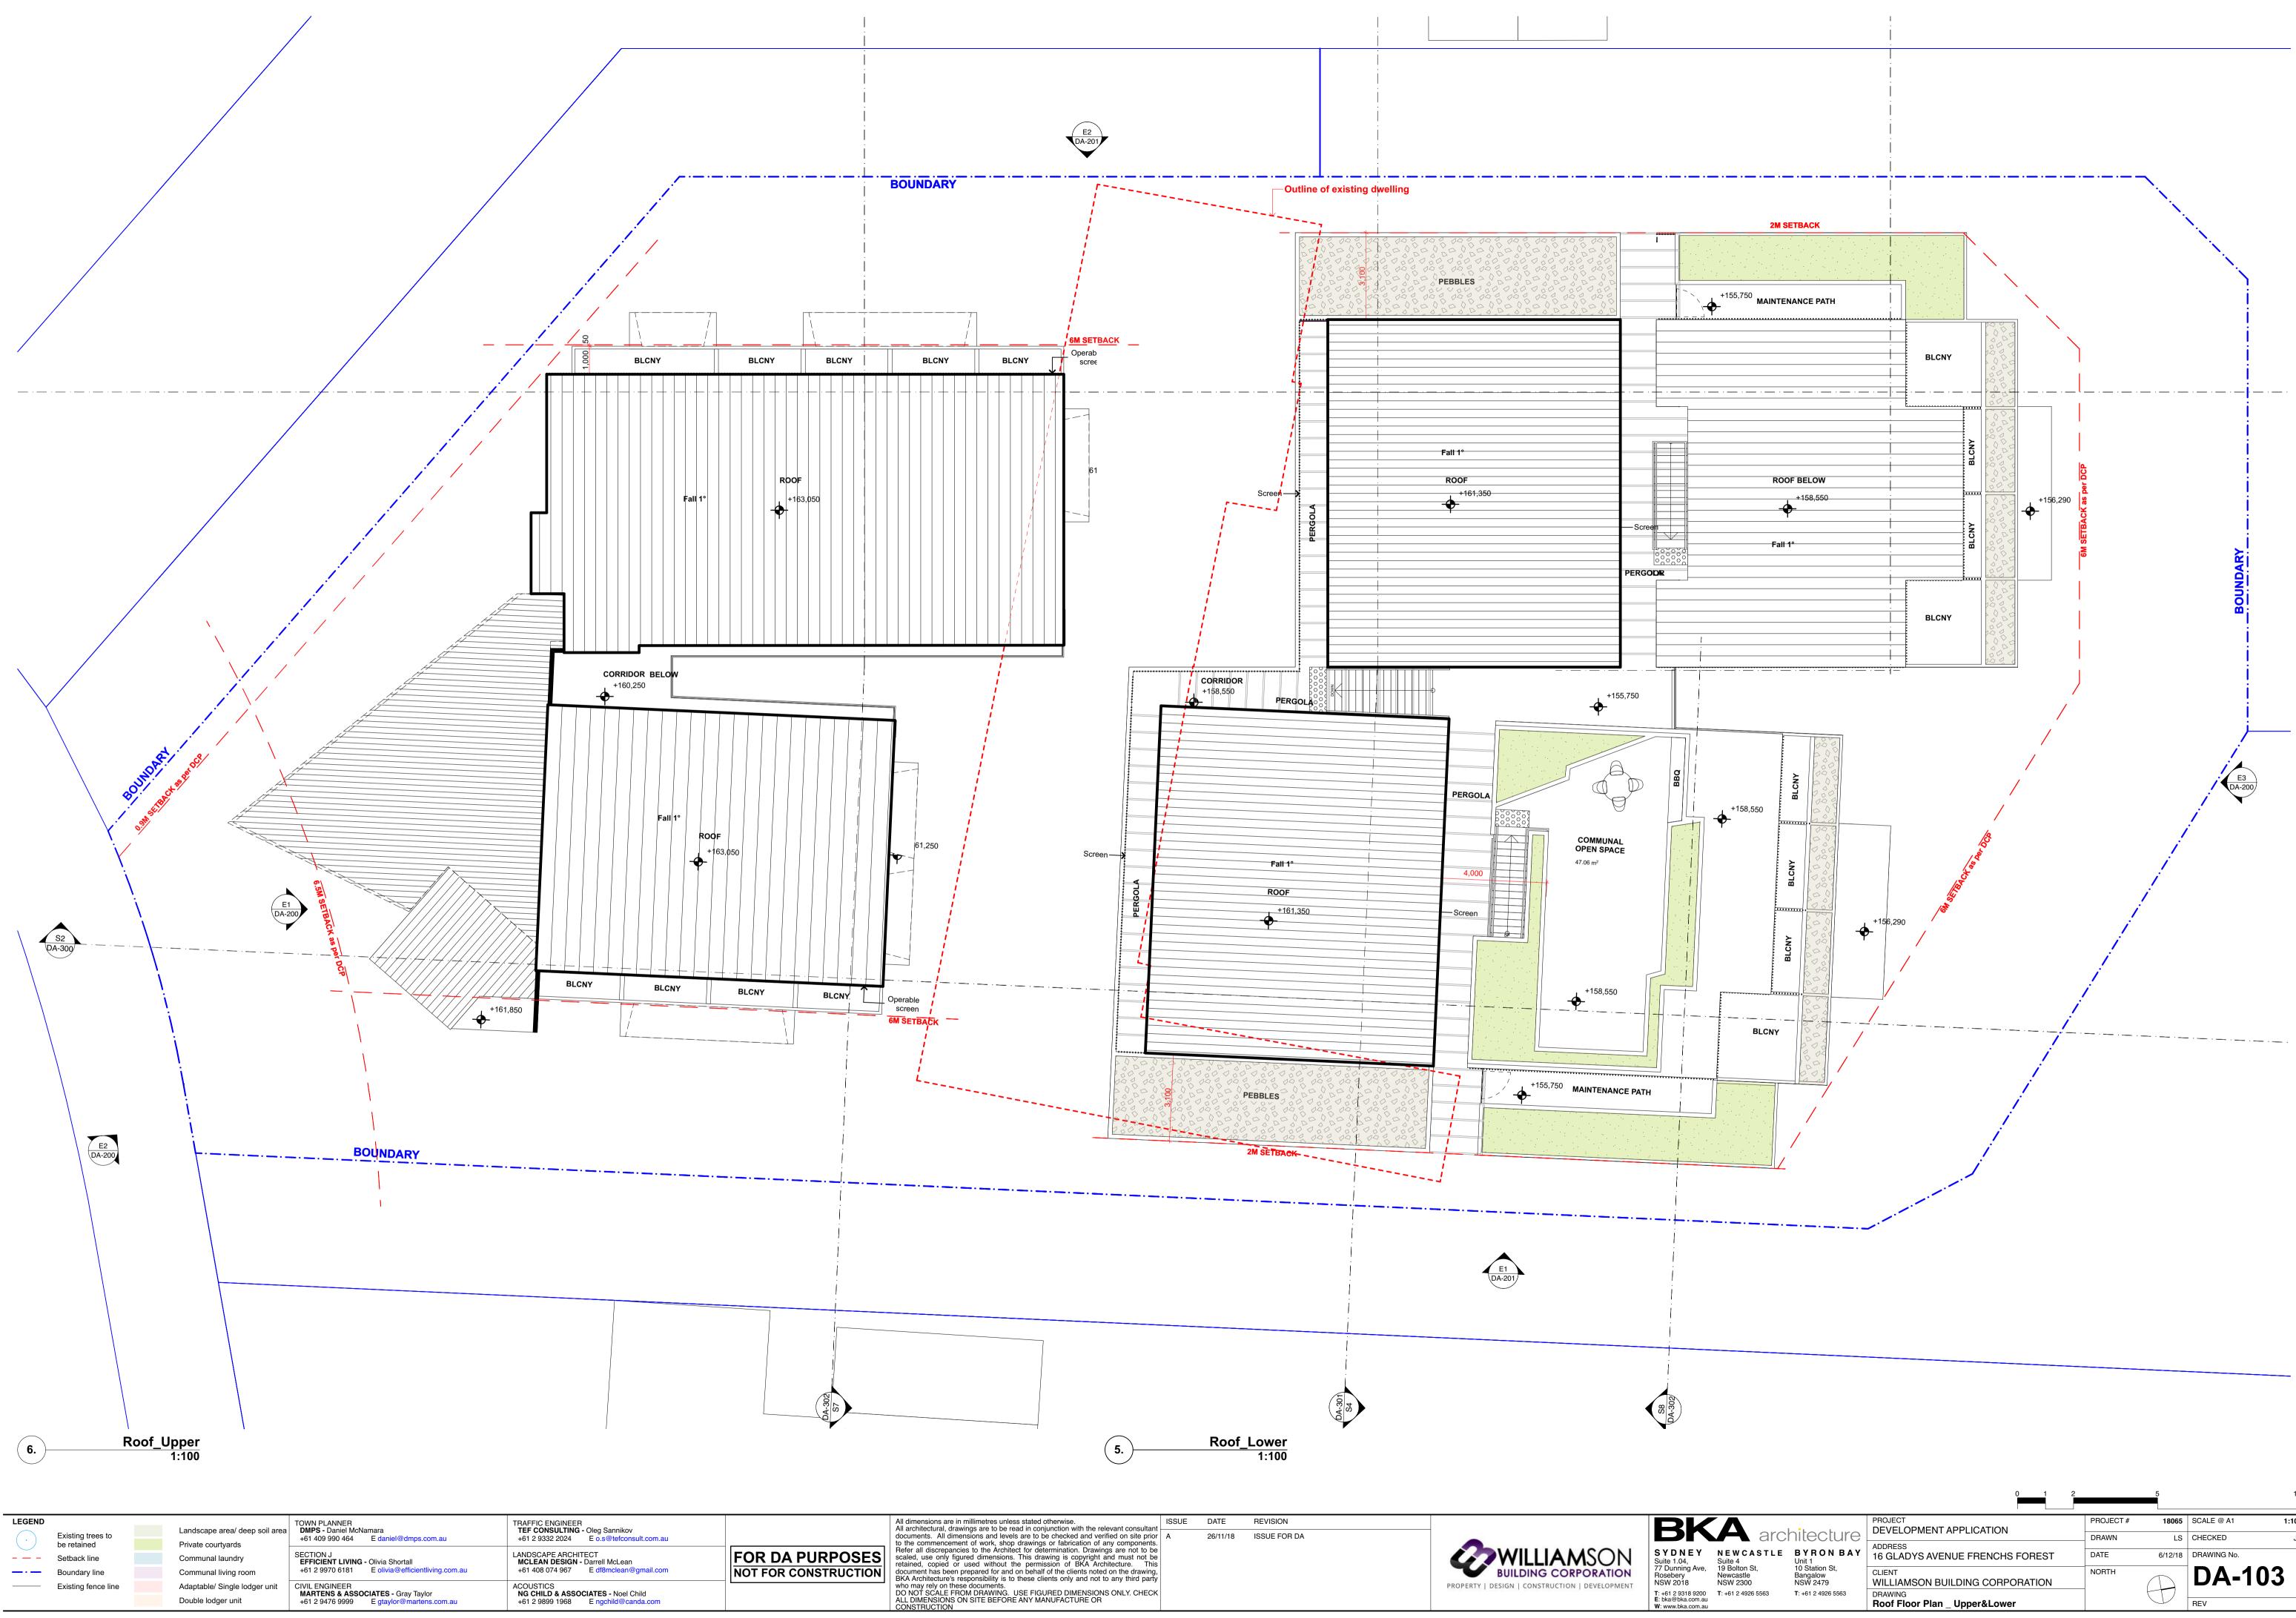

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e velo ke e k ve	PROJECT DEVELOPMENT APPLICATION	PROJECT # 18065	SCALE @ A1 1:100
architecture		DRAWN LS	CHECKED JK
ASTLE BYRON BAY Unit 1	ADDRESS 16 GLADYS AVENUE FRENCHS FOREST	DATE 6/12/18	DRAWING No.
St,10 Station St,eBangalow10NSW 2479	CLIENT WILLIAMSON BUILDING CORPORATION	NORTH	<b>DA-103</b>
26 5563 <b>T</b> : +61 2 4926 5563	DRAWING Roof Floor Plan _ Upper&Lower	$\square$	REV A

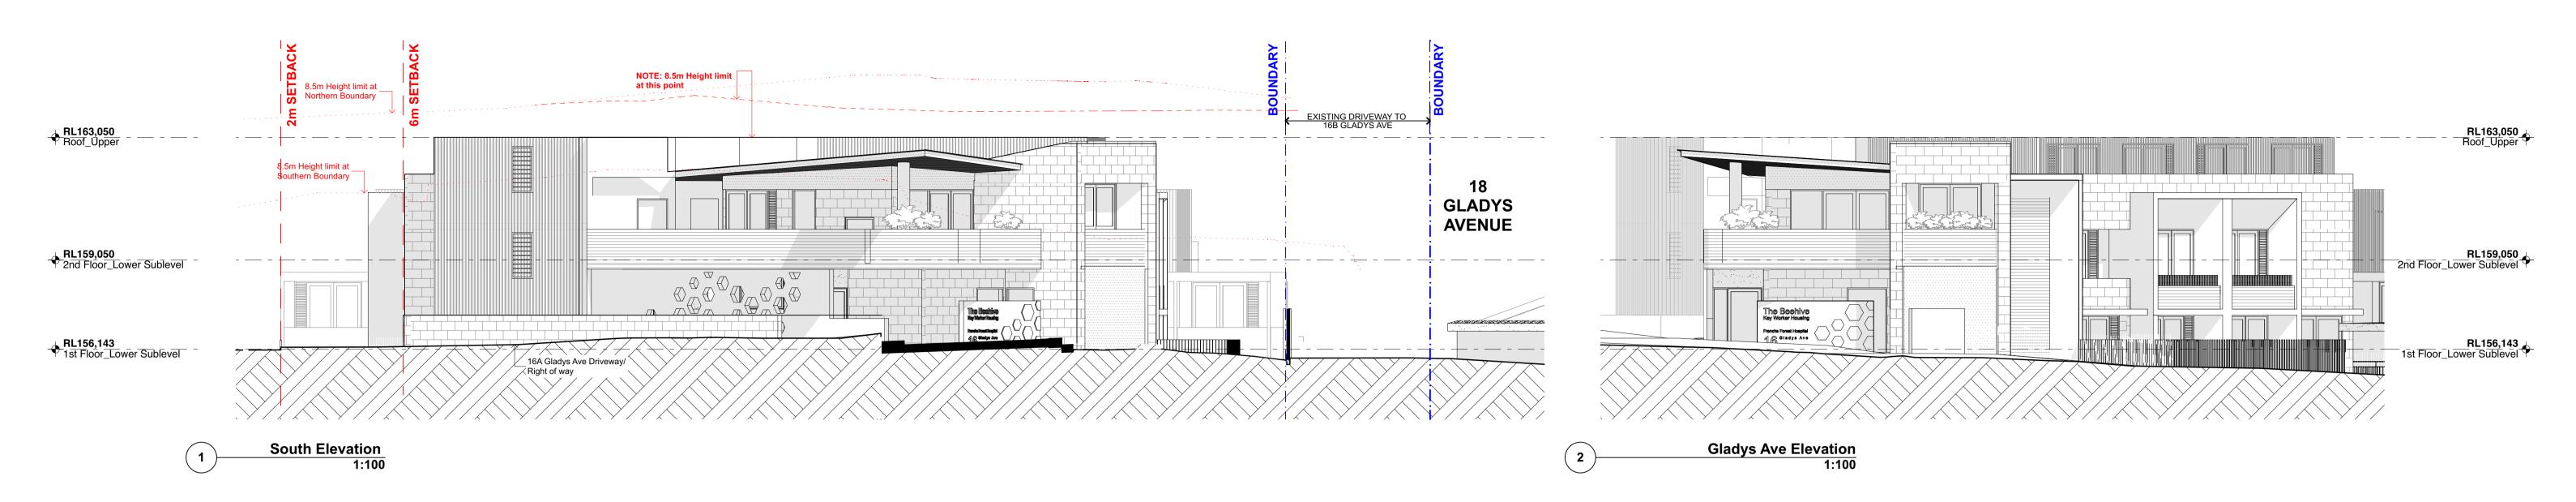




LEGEND SETBACK LINE	TOWN PLANNER DMPS - Daniel McNamara +61 409 990 464 E daniel@dmps.com.au	TRAFFIC ENGINEER <b>TEF CONSULTING -</b> Oleg Sannikov +61 2 9332 2024 E o.s@tefconsult.com.au	
BOUNDARY LINE HEIGHT LIMIT LINE	SECTION J <b>EFFICIENT LIVING -</b> Olivia Shortall +61 2 9970 6181 E olivia@efficientliving.com.au	LANDSCAPE ARCHITECT MCLEAN DESIGN - Darrell McLean +61 408 074 967 E df8mclean@gmail.com	FOR DA PURPOSES
	CIVIL ENGINEER MARTENS & ASSOCIATES - Gray Taylor +61 2 9476 9999 E gtaylor@martens.com.au	ACOUSTICS NG CHILD & ASSOCIATES - Noel Child +61 2 9899 1968 E ngchild@canda.com	




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		PROJECT DEVELOPMENT APPLICATION			PROJECT #	18065	SCALE @ A1	1:100
arc	hitecture				DRAWN	LS	CHECKED	JK
ASTLE	BYRON BAY Unit 1	ADDRESS 16 GLADYS AVENUE FRENCHS	FOREST		DATE	6/12/18	DRAWING No.	
n St, 10 Station St, le Bangalow 00 NSW 2479		CLIENT WILLIAMSON BUILDING CORPO	RATION		NORTH	$\square$	<b>DA-2</b>	00
926 5563	<b>T</b> : +61 2 4926 5563	DRAWING North & South Elevations				$\Box$	REV	A
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West Elevation 2 1:100




EGEND SETBACK LINE	TOWN PLANNER DMPS - Daniel McNamara +61 409 990 464 E daniel@dmps.com.au	TRAFFIC ENGINEER <b>TEF CONSULTING</b> - Oleg Sannikov +61 2 9332 2024 E o.s@tefconsult.com.au	
BOUNDARY LINE HEIGHT LIMIT LINE	SECTION J EFFICIENT LIVING - Olivia Shortall +61 2 9970 6181 E olivia@efficientliving.com.au	LANDSCAPE ARCHITECT MCLEAN DESIGN - Darrell McLean +61 408 074 967 E df8mclean@gmail.com	FOR DA PURPO
	CIVIL ENGINEER MARTENS & ASSOCIATES - Gray Taylor +61 2 9476 9999 E gtaylor@martens.com.au	ACOUSTICS NG CHILD & ASSOCIATES - Noel Child +61 2 9899 1968 E nochild@canda.com	

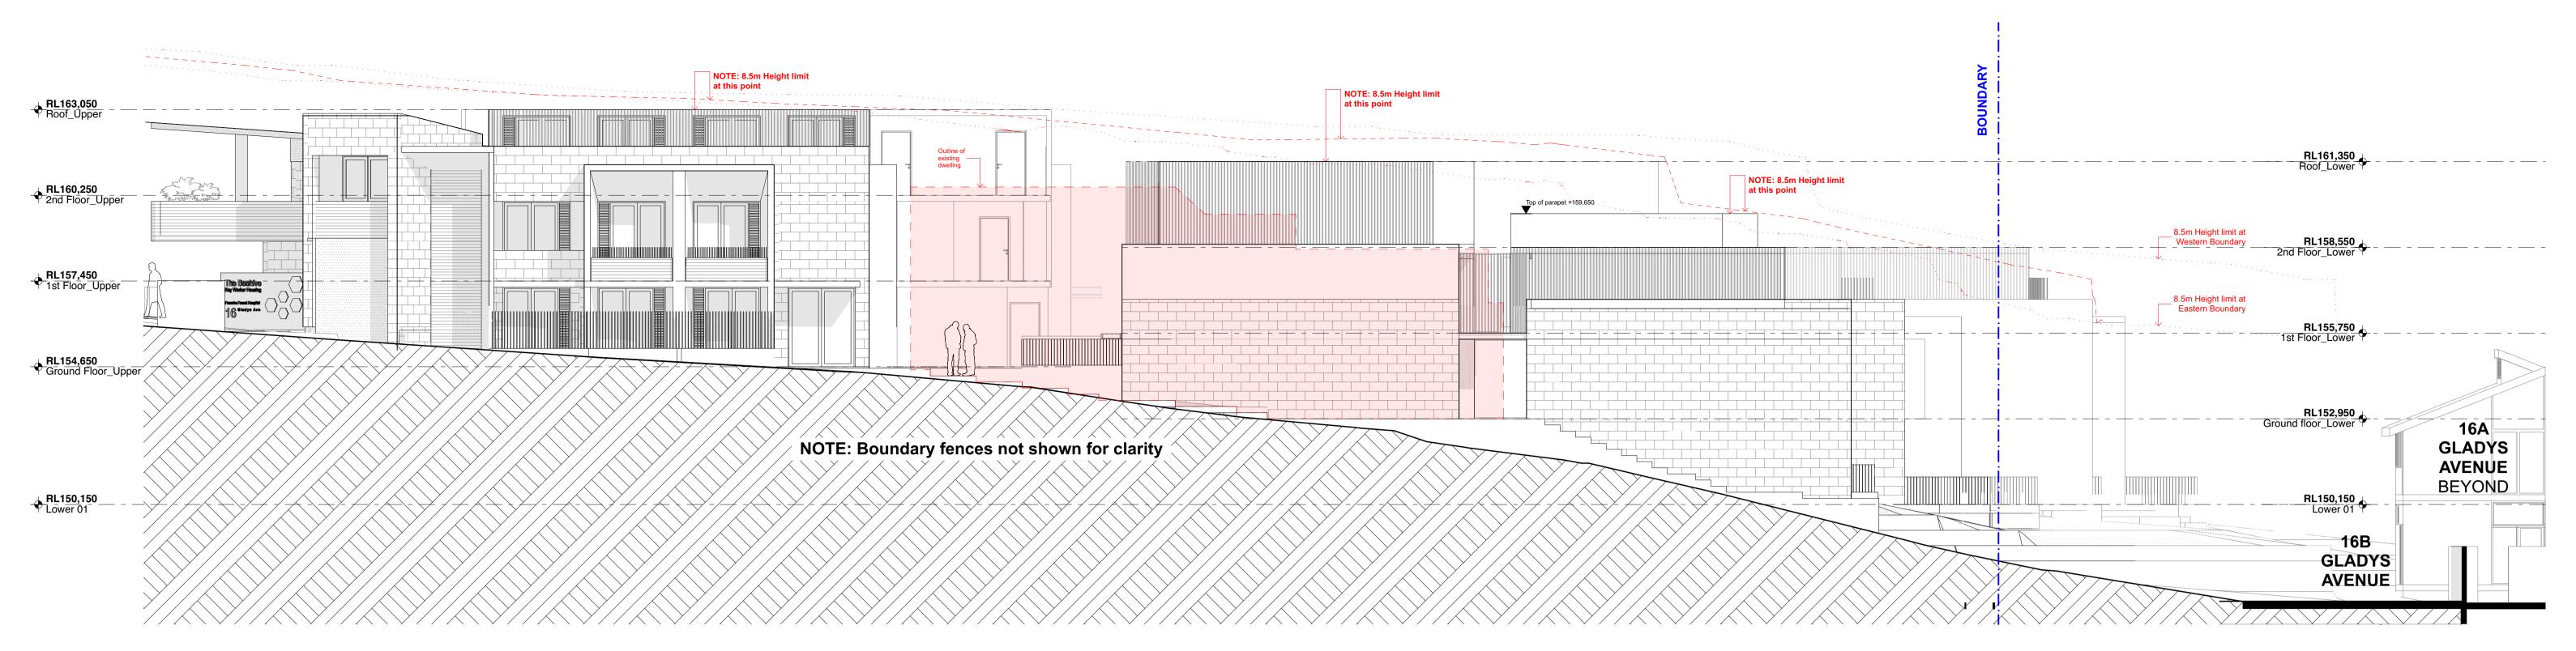REVISION

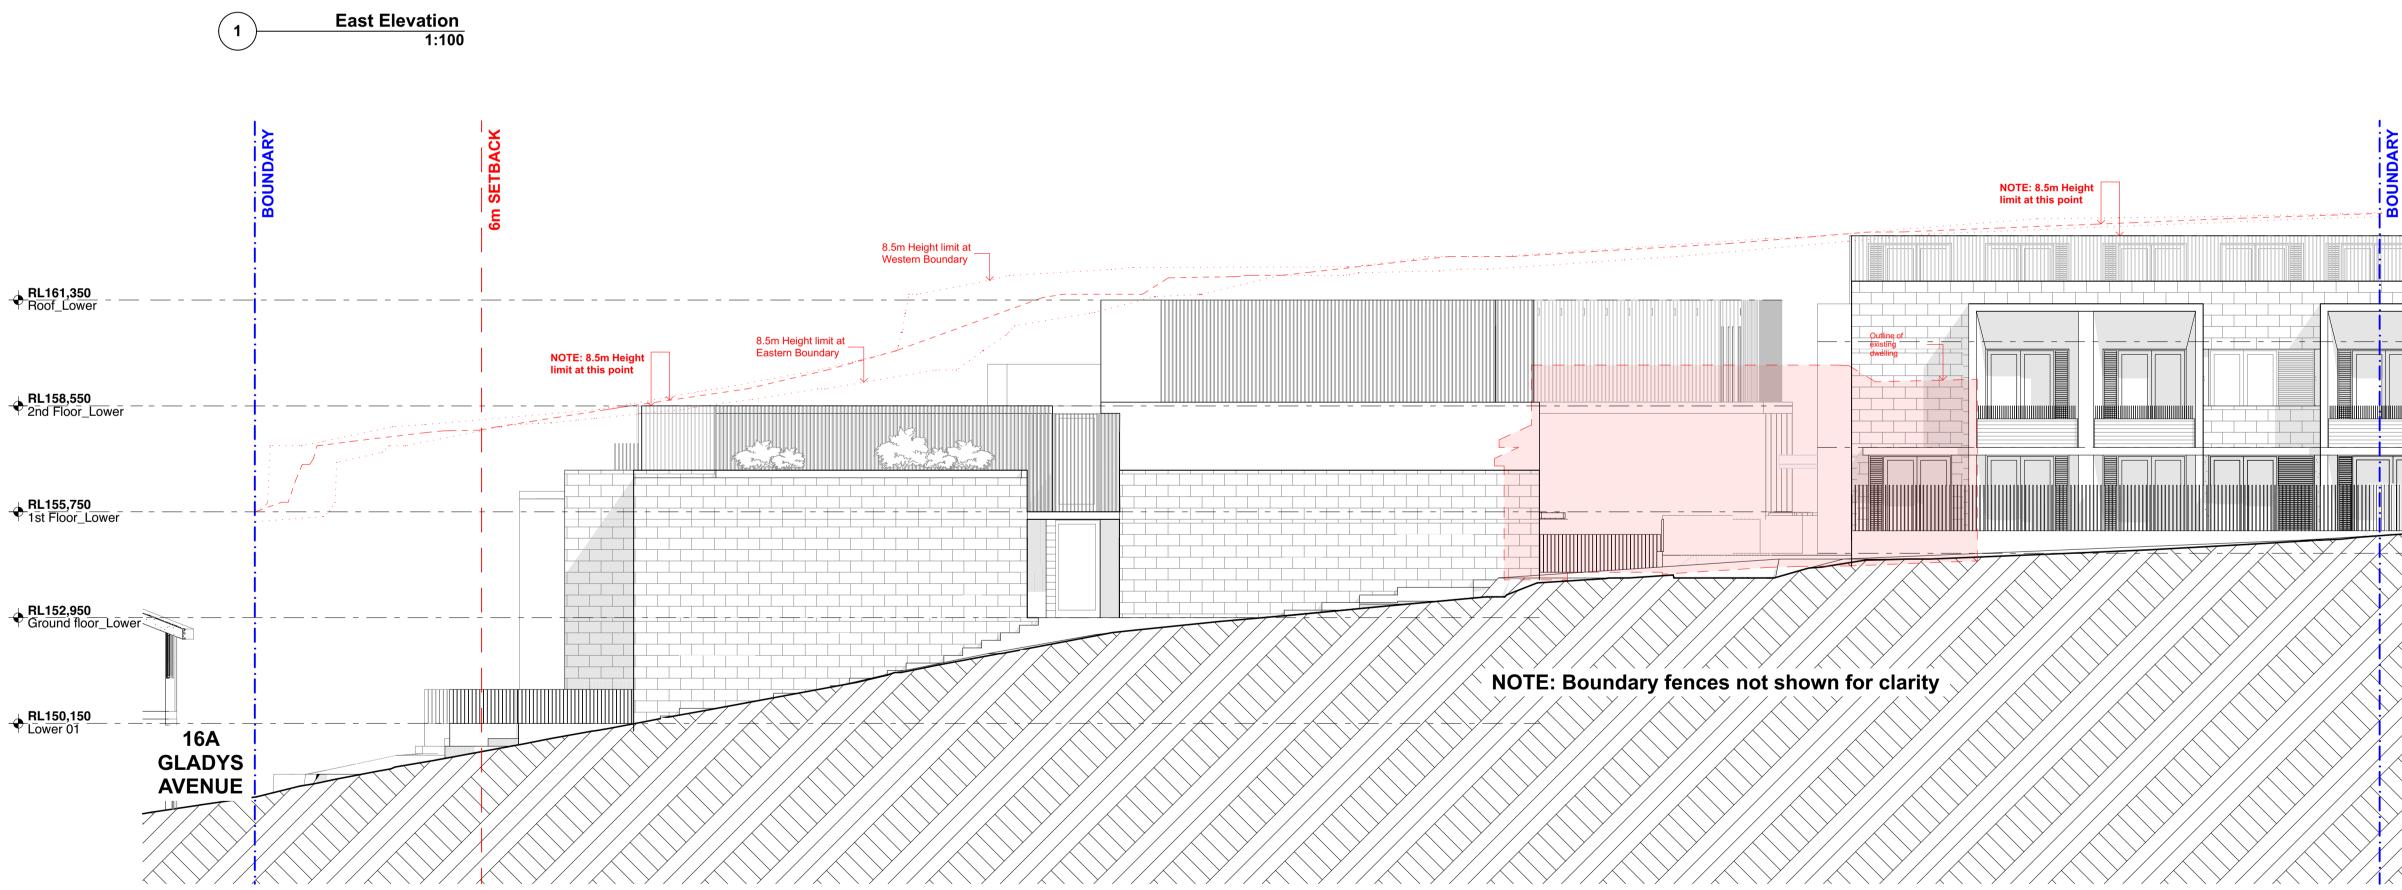ISSUE DATE






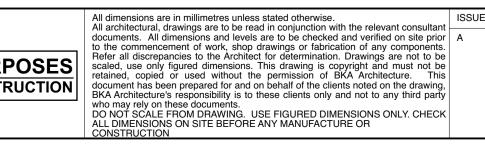

BOUNDARY	2014년 201 2014년 2014년 2014	
		<b>RL163,050</b> Roof_Upper ♥
		<b>RL160,250</b> 2nd Floor_Upper
		<b>RL157,450</b> 1st Floor_Upper <del></del>
		RL154,650 Ground Floor_Upper

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		PROJECT DEVELOPMENT APPLICATION	PROJECT #	18065	SCALE @ A1	1:100
arc	hitecture	ADDRESS	DRAWN	LS	CHECKED	JK
ASTLE	BYRON BAY Unit 1	16 GLADYS AVENUE FRENCHS FOREST	DATE	6/12/18	DRAWING No.	
e 10 Station St, Bangalow NSW 2479		CLIENT WILLIAMSON BUILDING CORPORATION	NORTH	$\square$	<b>DA-20</b> <sup>2</sup>	1
26 5563	<b>T</b> : +61 2 4926 5563	DRAWING West & East Elevations		D	REV	Α



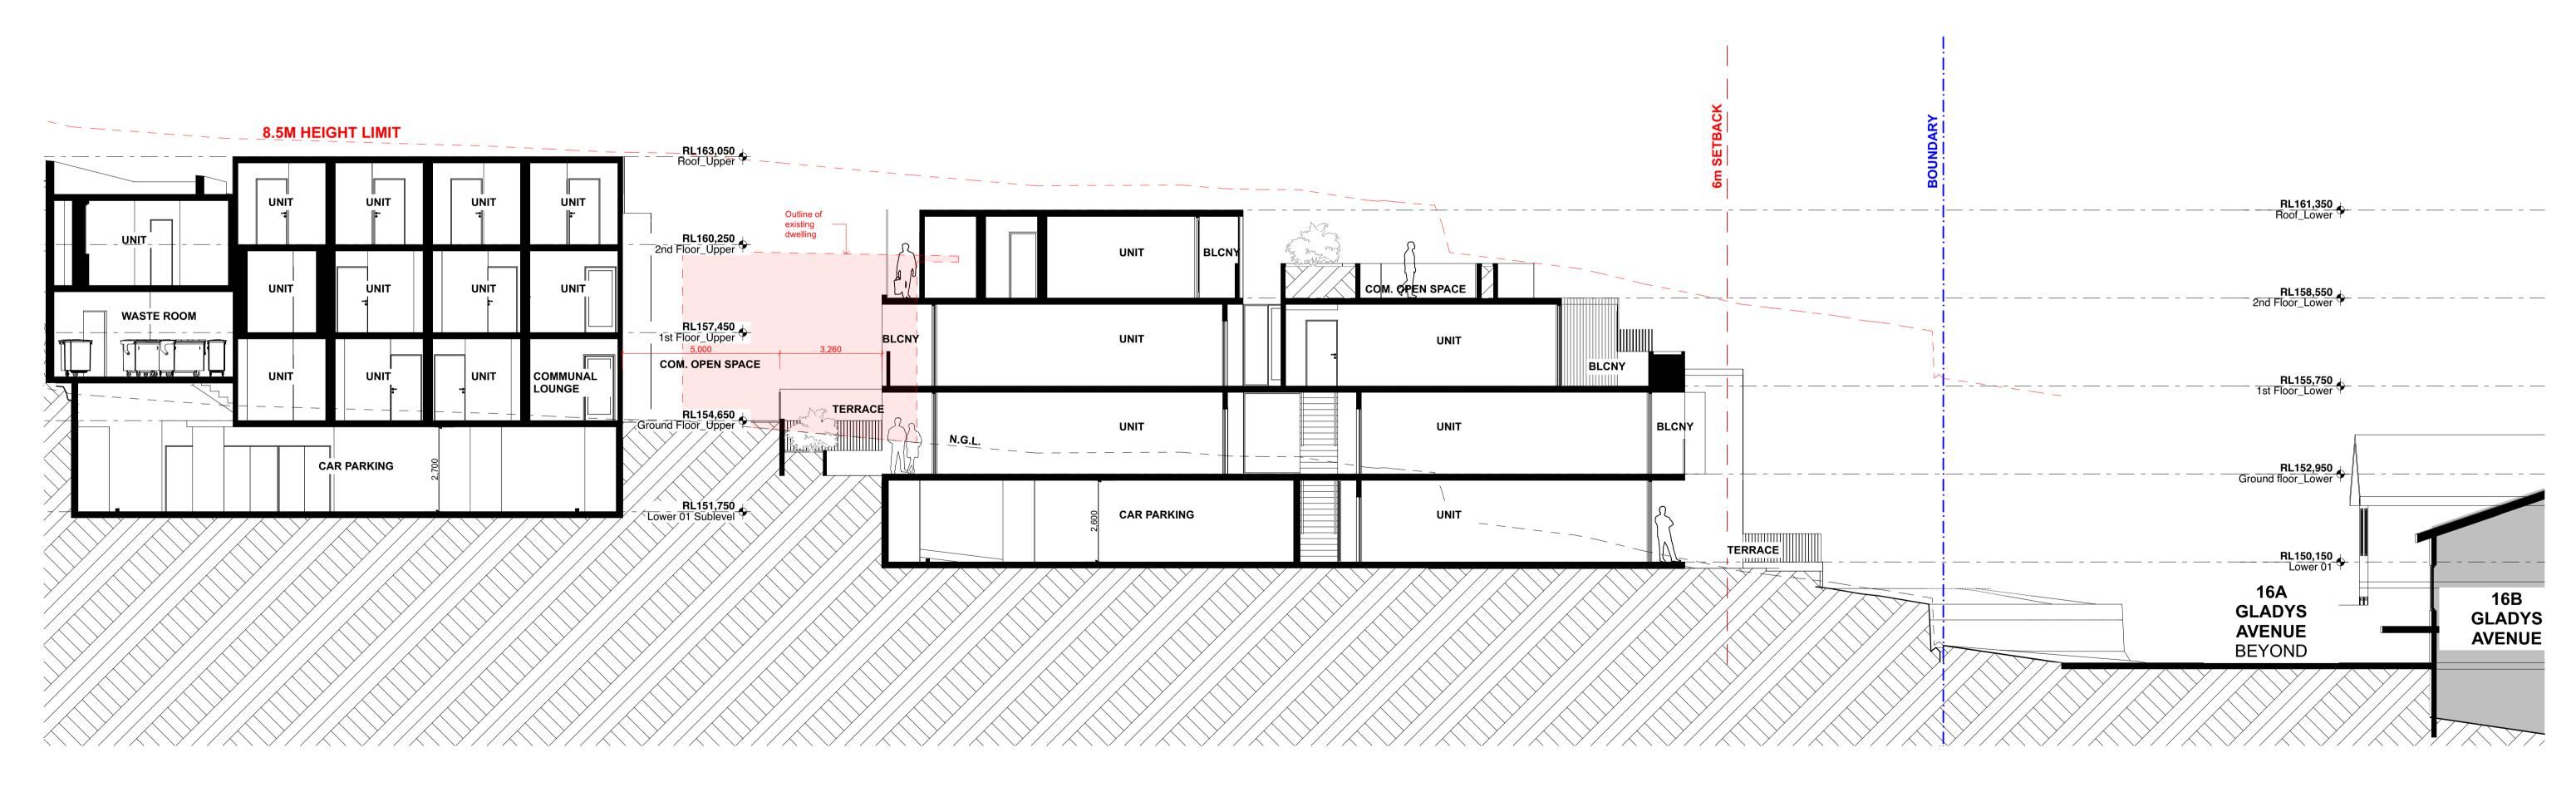

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26/11/18 ISSUE FOR DA


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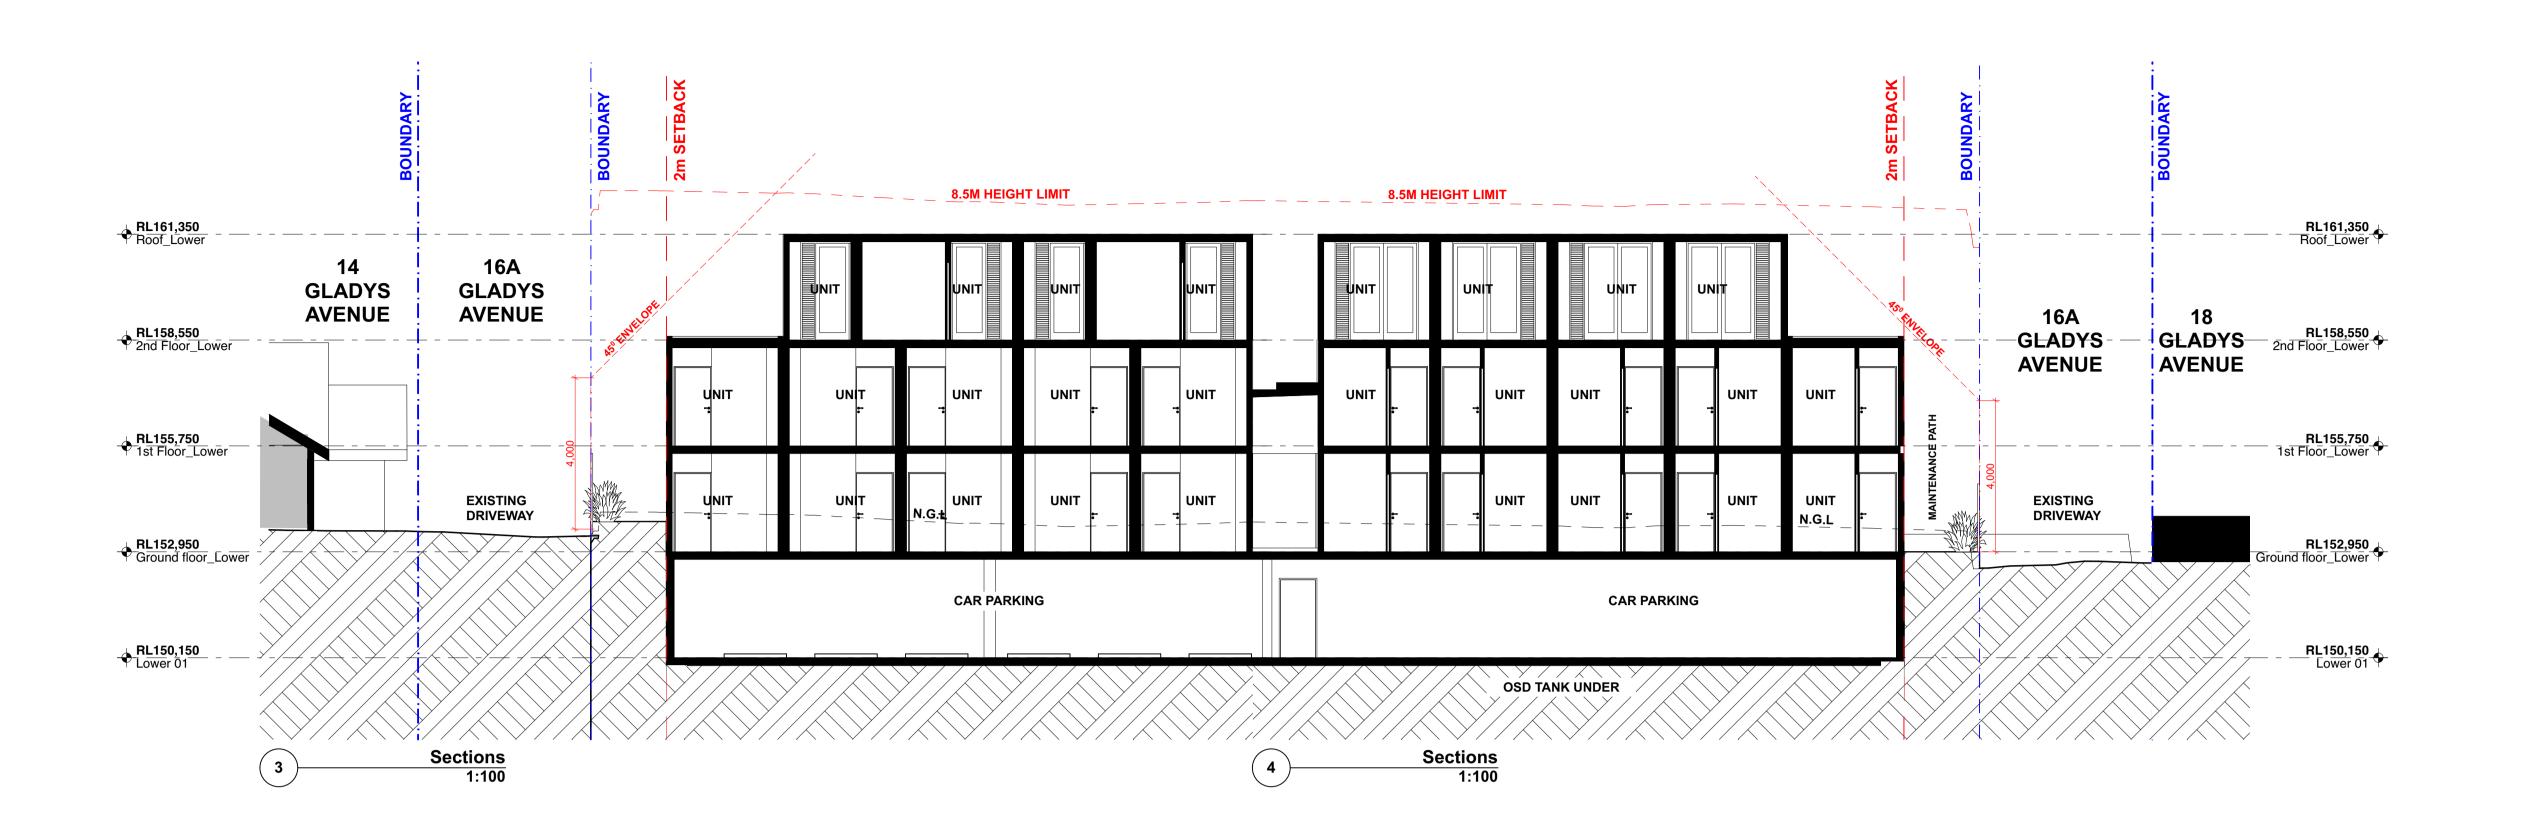
GEND	
<u> </u>	SETBACK LINE
	BOUNDARY LINE
	HEIGHT LIMIT LINE


TOWN PLANNER DMPS - Daniel McNamara +61 409 990 464 E daniel@dmps.com.au	TRAFFIC ENGINEER <b>TEF CONSULTING -</b> Oleg Sannikov +61 2 9332 2024 E o.s@tefconsult.com.au		
SECTION J <b>EFFICIENT LIVING -</b> Olivia Shortall +61 2 9970 6181 E olivia@efficientliving.com.au	LANDSCAPE ARCHITECT MCLEAN DESIGN - Darrell McLean +61 408 074 967 E df8mclean@gmail.com	FOR DA PURPOSES	
CIVIL ENGINEER MARTENS & ASSOCIATES - Gray Taylor +61 2 9476 9999 E gtaylor@martens.com.au	ACOUSTICS NG CHILD & ASSOCIATES - Noel Child +61 2 9899 1968 E ngchild@canda.com		






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ASTLE BYRON BA	Y ADDRESS 16 GLADYS AVENUE FRENCHS FOREST	DATE 6/12/1	3 DRAWING No.
St,10 Station St,eBangalow0NSW 2479	CLIENT WILLIAMSON BUILDING CORPORATION	NORTH	<b>DA-300</b>
26 5563 <b>T</b> : +61 2 4926 5563	DRAWING Sections 1 & 2		REV A

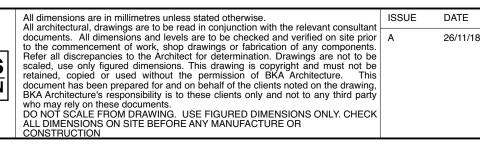

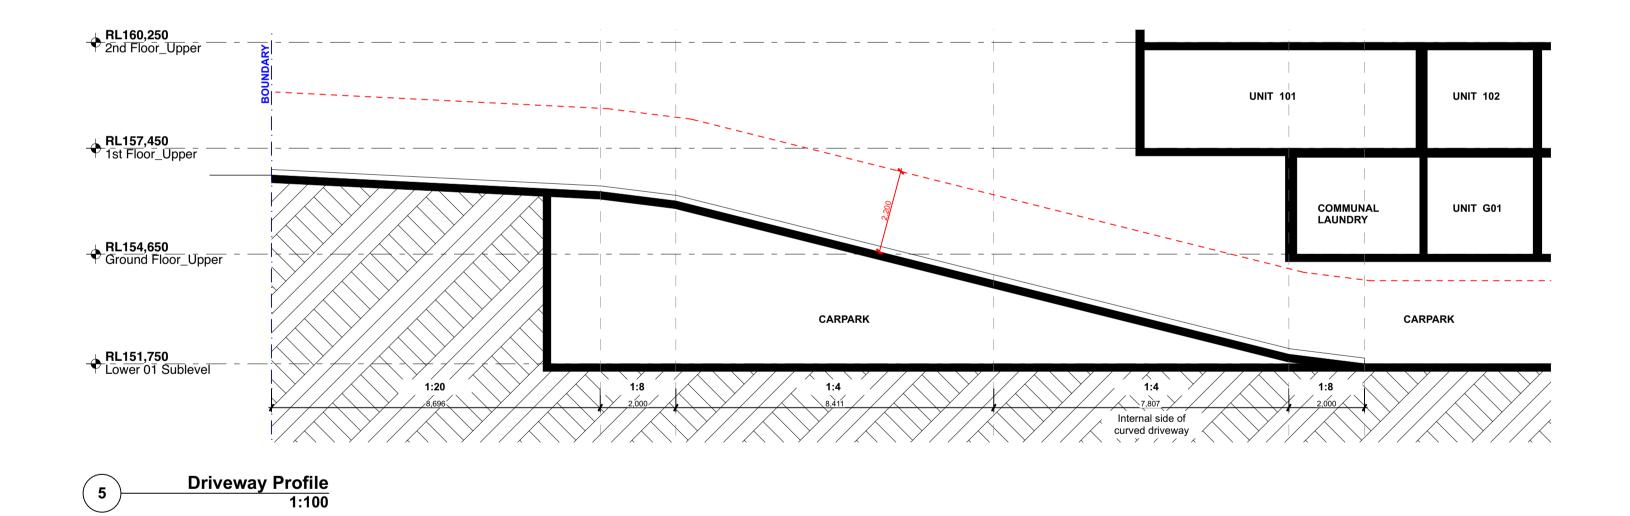


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BOUNDARY LINE     HEIGHT LIMIT LINE	SECTION J <b>EFFICIENT LIVING -</b> Olivia Shortall +61 2 9970 6181 E olivia@efficientliving.com.au	LANDSCAPE ARCHITECT MCLEAN DESIGN - Darrell McLean +61 408 074 967 E df8mclean@gmail.com	FOR DA PURPOSES
	CIVIL ENGINEER MARTENS & ASSOCIATES - Gray Taylor +61 2 9476 9999 E gtaylor@martens.com.au	ACOUSTICS NG CHILD & ASSOCIATES - Noel Child +61 2 9899 1968 E ngchild@canda.com	



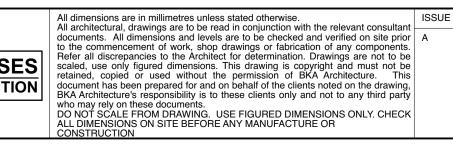

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		PROJECT DEVELOPMENT APPLICATION		PRO	JECT #	18065	SCALE @ A1	1:100
arc	hitecture			DRA	WN	LS	CHECKED	JK
ASTLE	BYRON BAY Unit 1	ADDRESS 16 GLADYS AVENUE FRENCHS	FOREST	DATE		6/12/18	DRAWING No.	
n St, 10 Station St, le Bangalow 00 NSW 2479		CLIENT WILLIAMSON BUILDING CORPO	ORATION	NOR	TH	$\square$	<b>DA-3</b>	01
926 5563	<b>T</b> : +61 2 4926 5563	DRAWING Sections 3-4 & 5				$\square$	REV	A

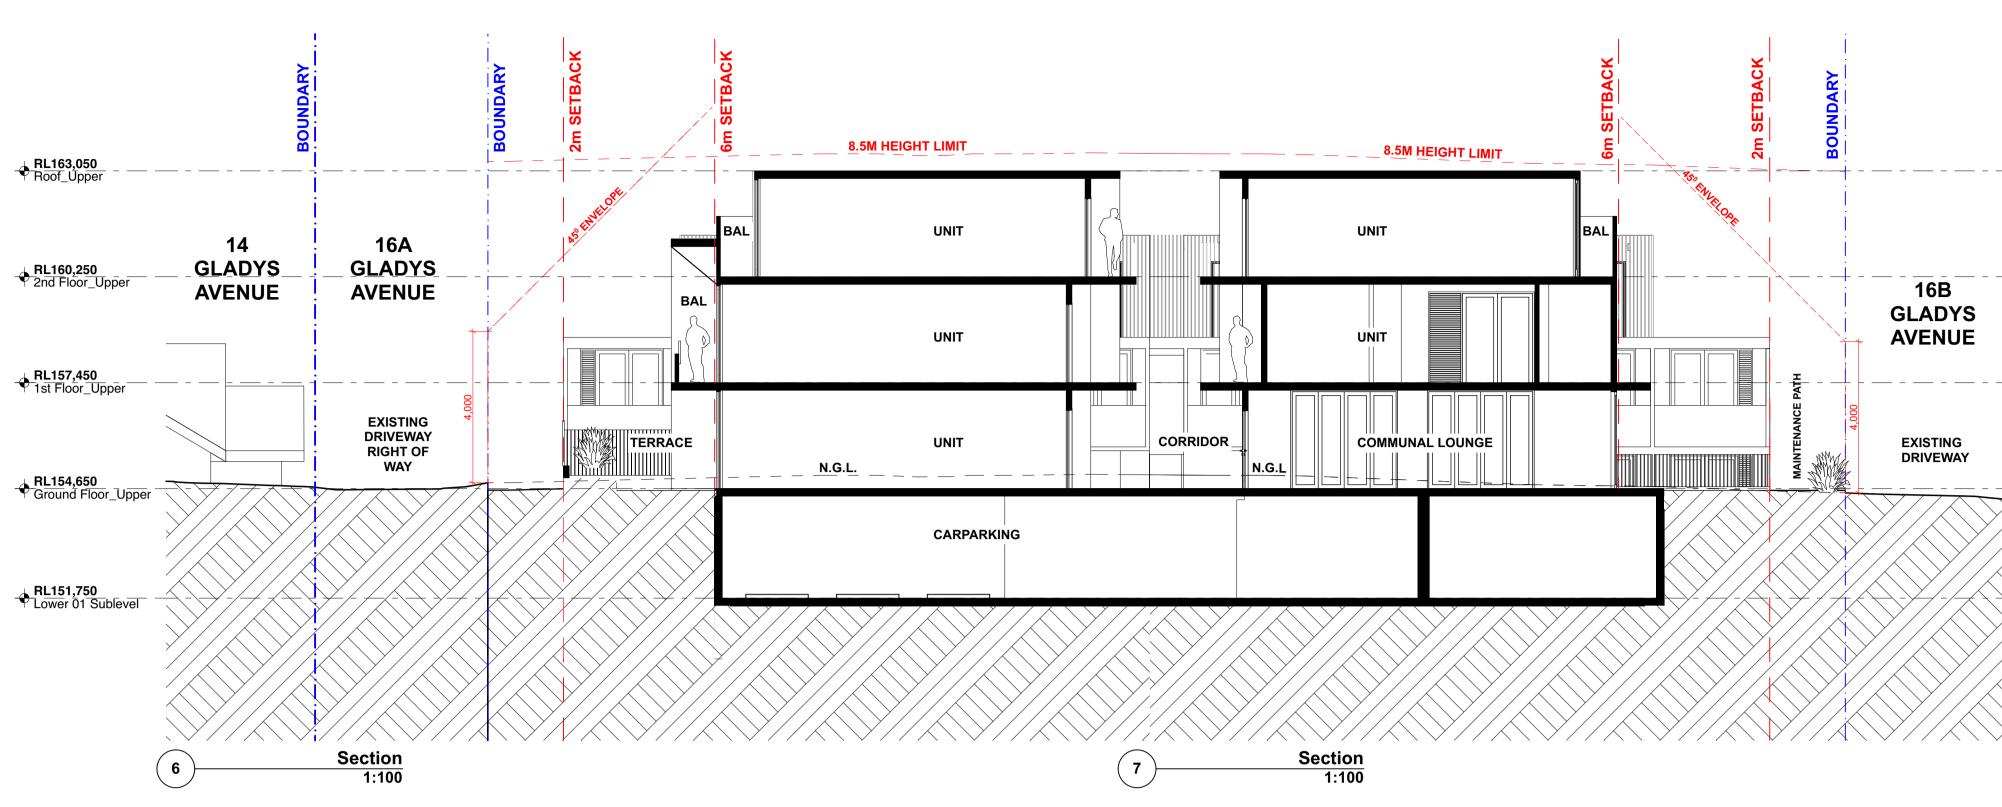



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BOUNDARY LINE BOUNDARY LINE HEIGHT LIMIT LINE	SECTION J EFFICIENT LIVING - Olivia Shortall +61 2 9970 6181 E olivia@efficientliving.com.au	LANDSCAPE ARCHITECT MCLEAN DESIGN - Darrell McLean +61 408 074 967 E df8mclean@gmail.com	FOR DA PURPOSES
	CIVIL ENGINEER MARTENS & ASSOCIATES - Gray Taylor +61 2 9476 9999 E gtaylor@martens.com.au	ACOUSTICS NG CHILD & ASSOCIATES - Noel Child +61 2 9899 1968 E ngchild@canda.com	

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26/11/18 ISSUE FOR DA






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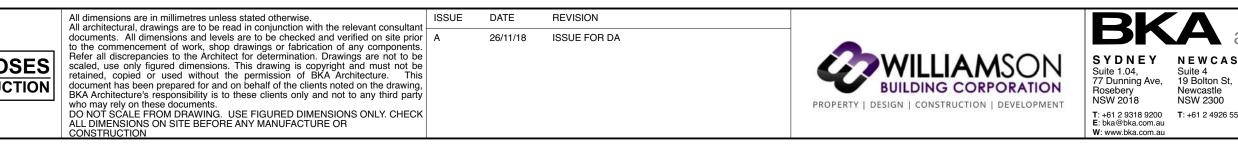


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arcr	nitecture			DRAWN	LS LS	CHECKED	JK
-	BYRON BAY Unit 1	ADDRESS 16 GLADYS AVENUE FRENCHS	S FOREST	DATE	6/12/18	DRAWING No.	
St, 10 Station St, Bangalow NSW 2479		CLIENT WILLIAMSON BUILDING CORP	ORATION	NORTH		<b>DA-3</b>	02
6 5563	T: +61 2 4926 5563	DRAWING Sections 6-7 & 8-9			$\square$	REV	A




**NOTE**: Shadows have been creating using the provided Site Survey. Shadows shown past the provided survey are indicative. Extent of Site Survey provided shown dashed in red.
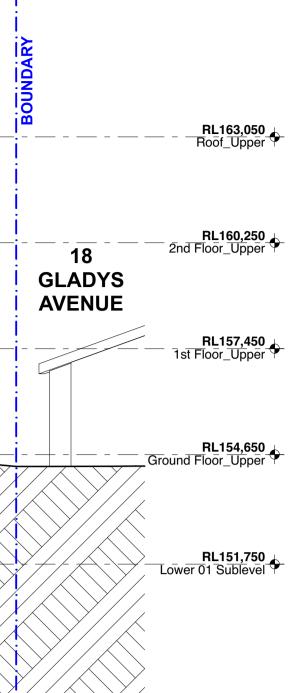
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	+61 2 9970 6181 E olivia@efficientliving.com.au	+61 408 074 967 E df8mclean@gmail.com	NOT FOR CONSTRUCT
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		PROJECT DEVELOPMENT APPLICATION	PROJECT #	18065	SCALE @ A1	1:250
arc	hitecture		DRAWN	LS	CHECKED	JK
ASTLE	BYRON BAY Unit 1	ADDRESS 16 GLADYS AVENUE FRENCHS FOREST	DATE	6/12/18	DRAWING No.	
St,10 Station St,BangalowNSW 2479	CLIENT WILLIAMSON BUILDING CORPORATION	NORTH	$\square$	DA-70	0	
26 5563	<b>T</b> : +61 2 4926 5563	DRAWING Shadow Diagrams		$\square$	REV	A



Winter Solstice, 21 June @ 3pm 1:250 **1**)
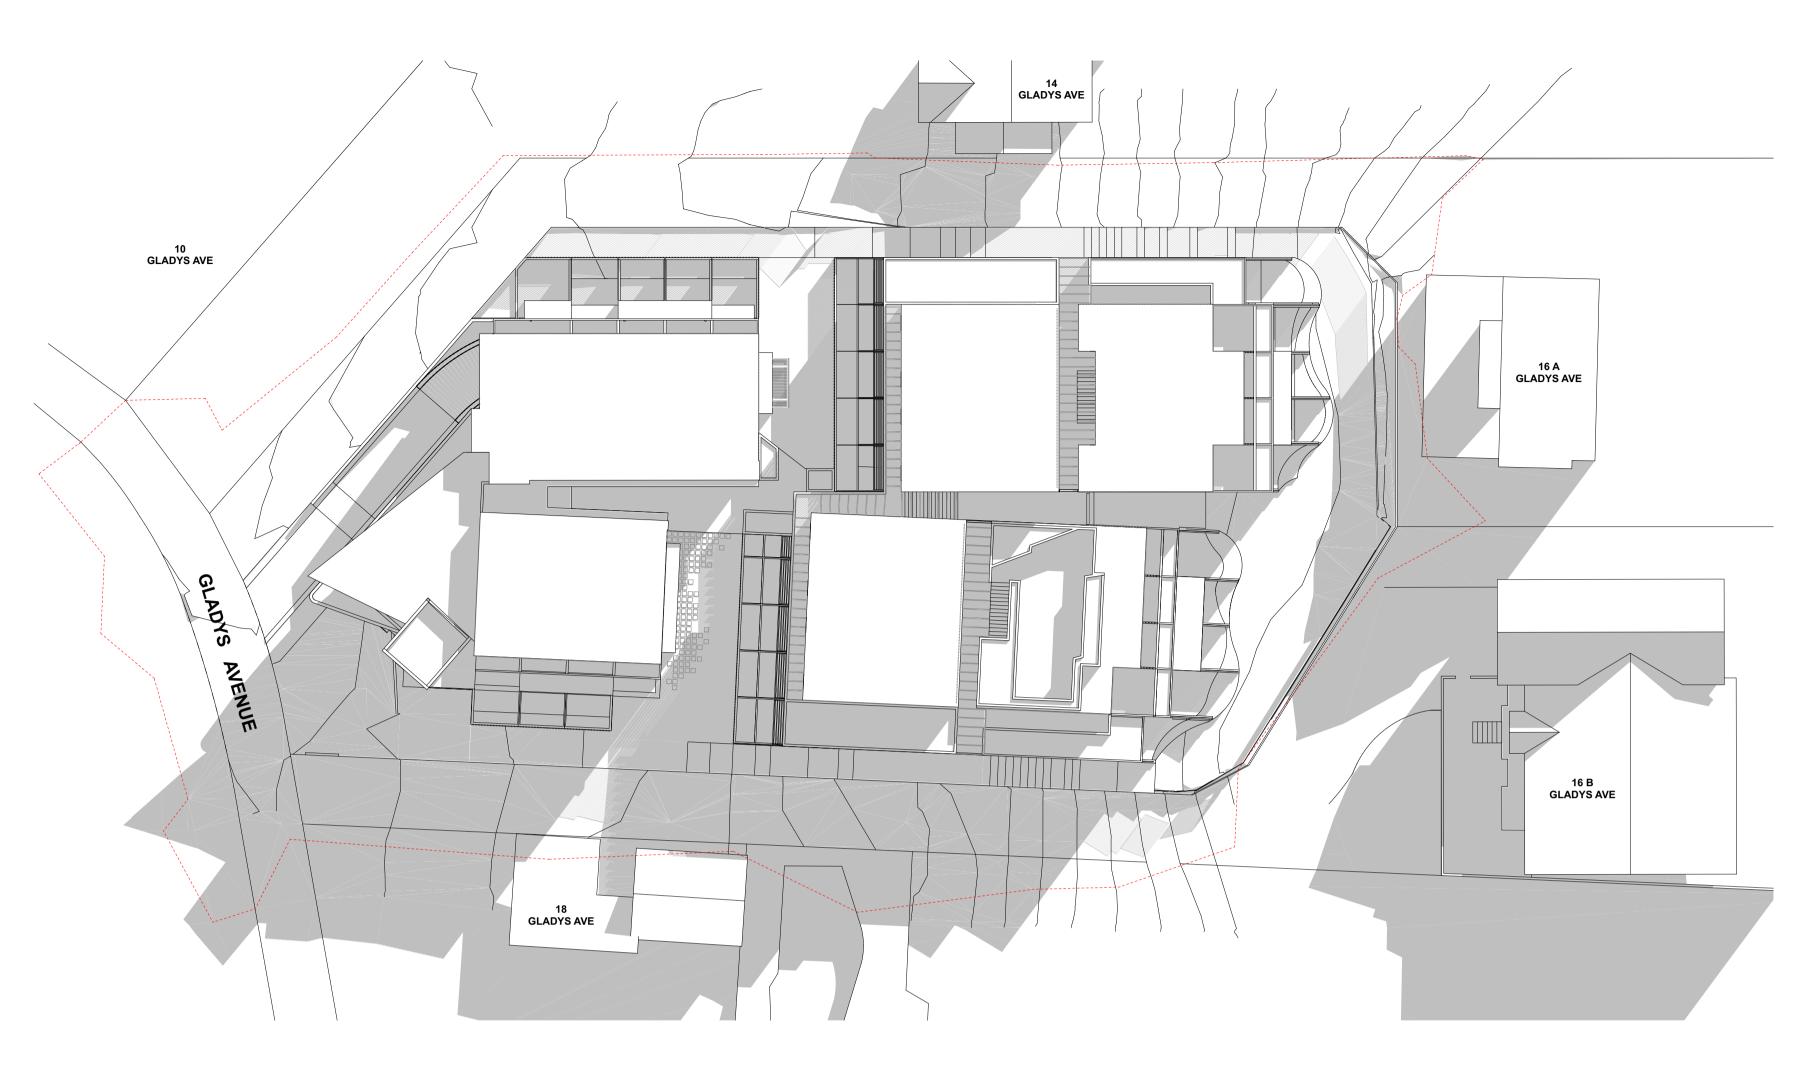
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	SECTION J <b>EFFICIENT LIVING -</b> Olivia Shortall +61 2 9970 6181 E olivia@efficientliving.com.au	LANDSCAPE ARCHITECT MCLEAN DESIGN - Darrell McLean +61 408 074 967 E df8mclean@gmail.com	FOR DA PURPOSES
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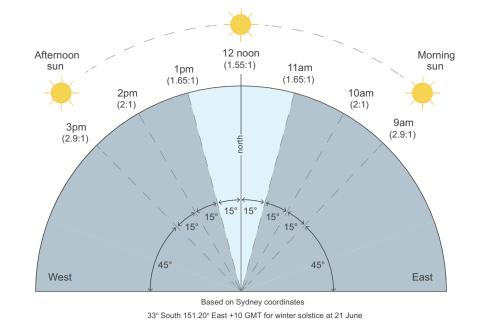
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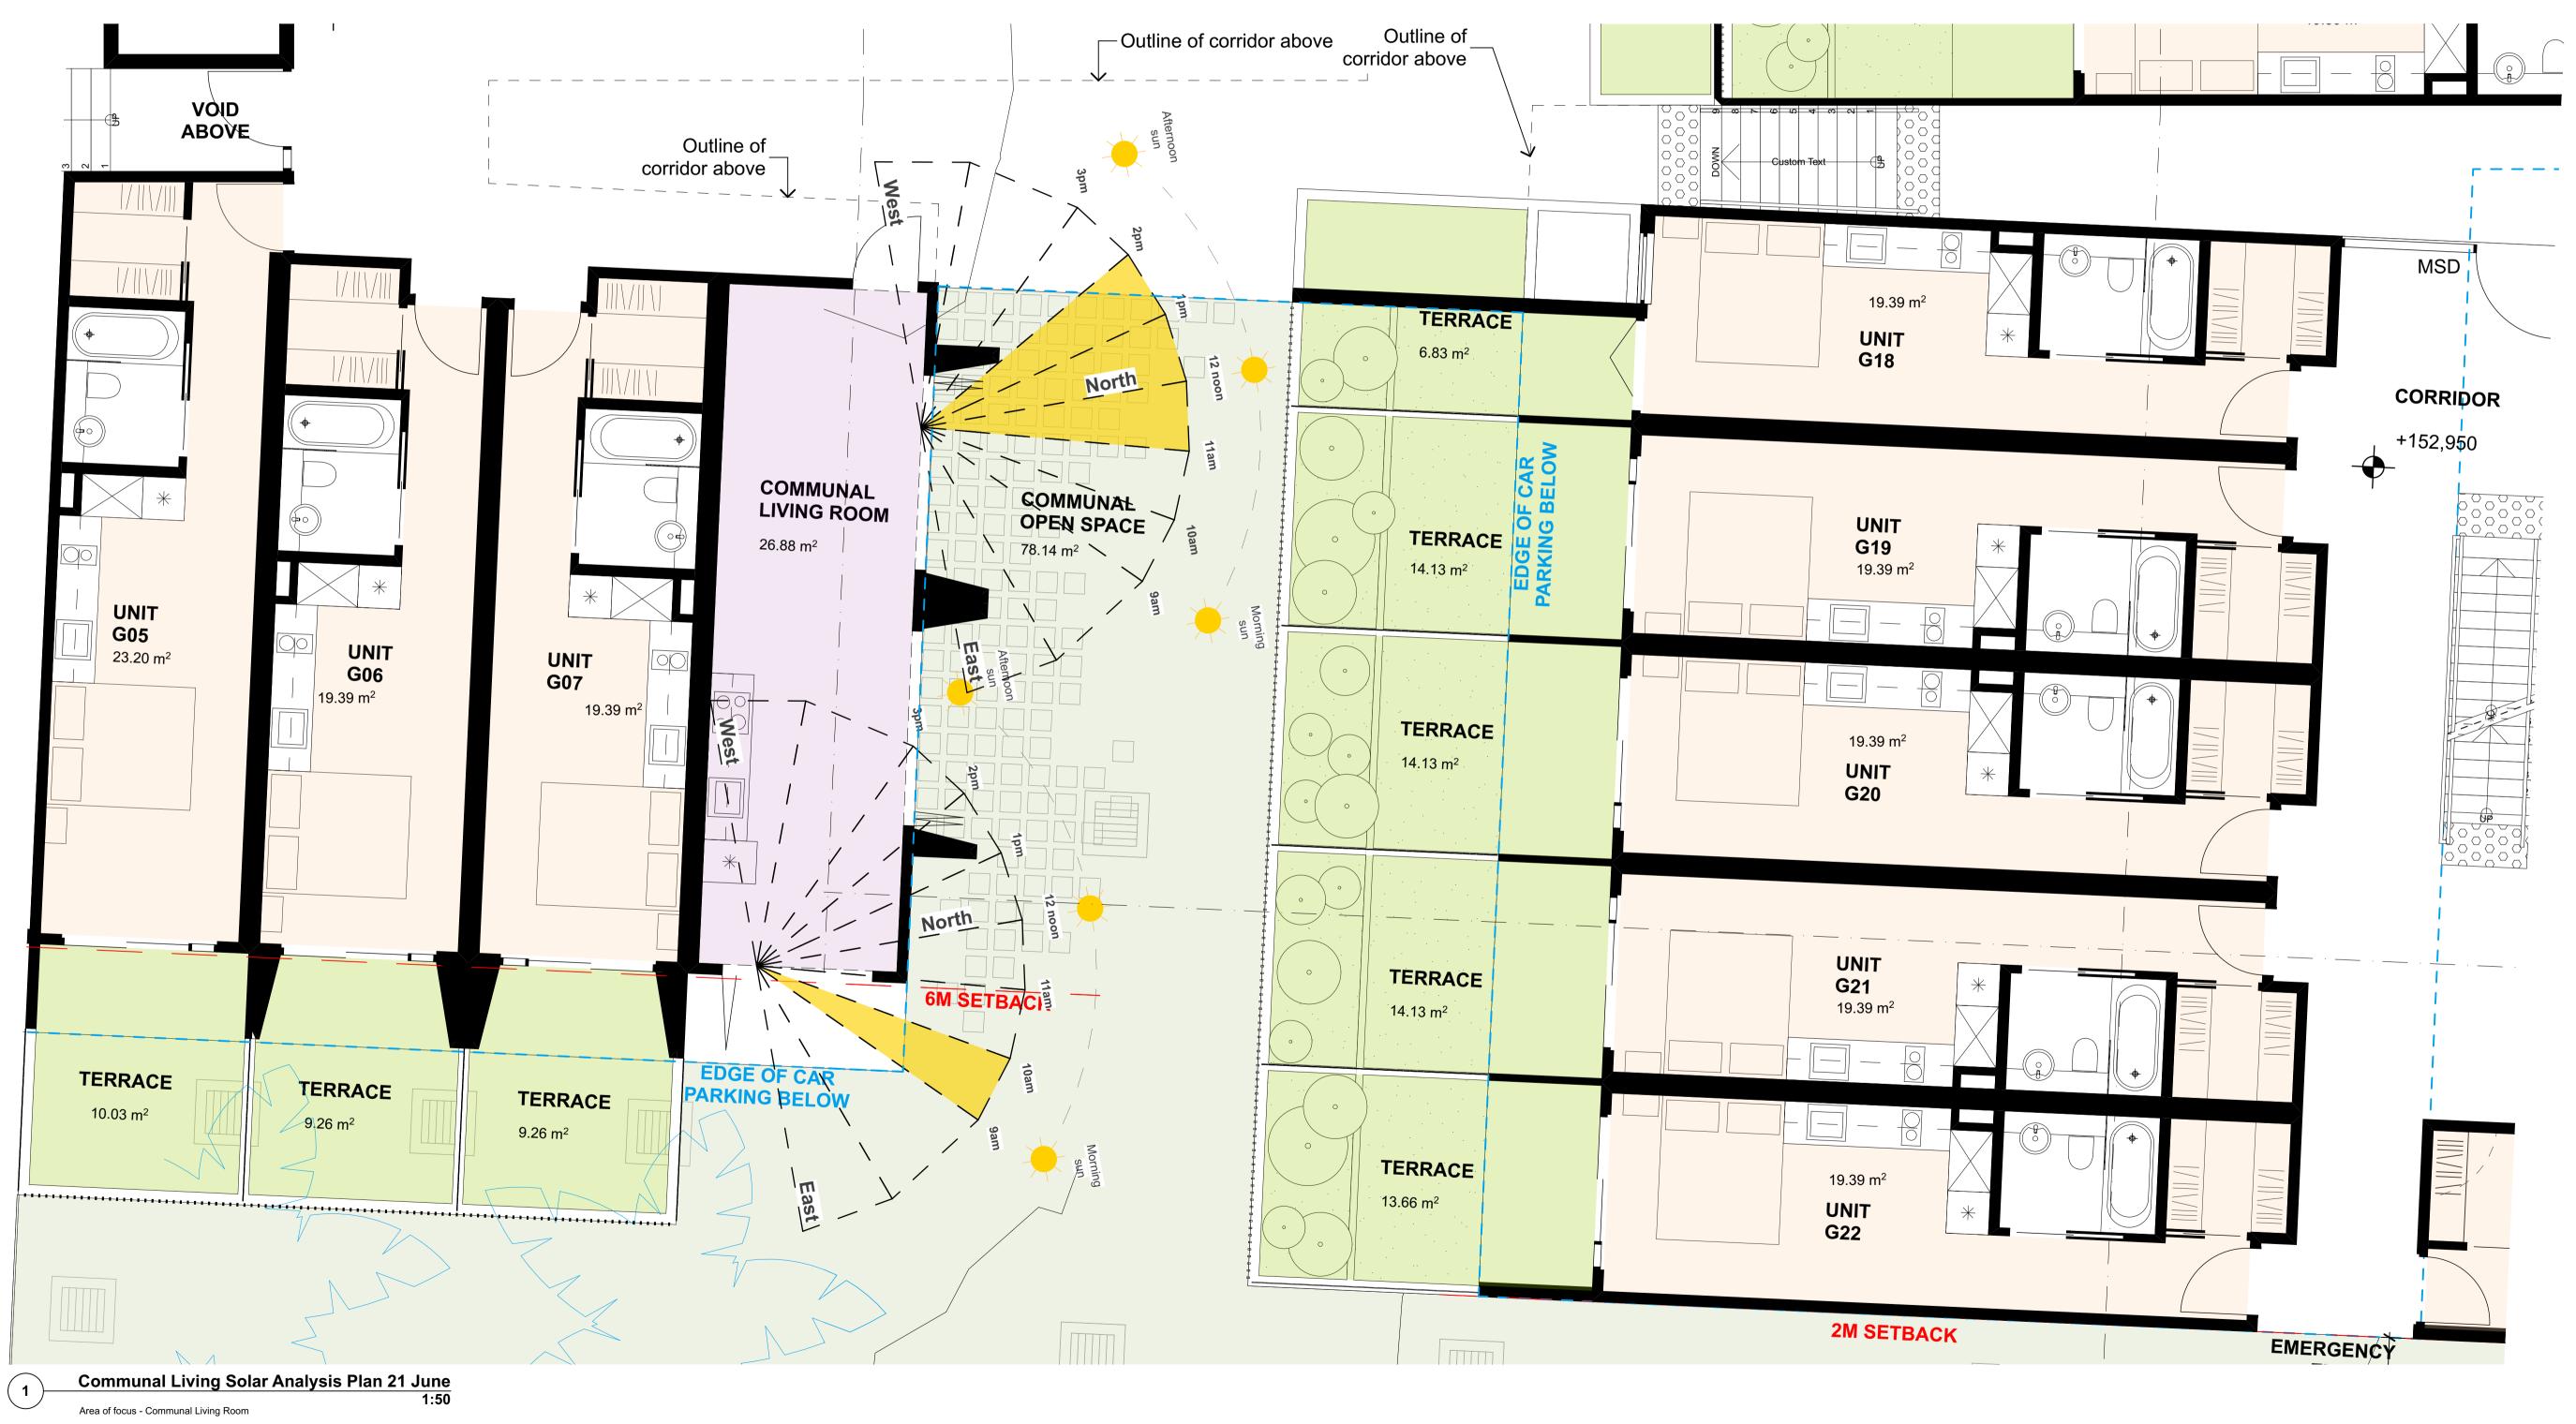
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		PROJECT DEVELOPMENT APPLICATION	PROJECT #	18065	SCALE @ A1	1:250
arc	hitecture		DRAWN	LS	CHECKED	JK
ASTLE	BYRON BAY Unit 1	ADDRESS 16 GLADYS AVENUE FRENCHS FOREST	DATE	6/12/18	DRAWING No.	
e 10 Station St, Bangalow NSW 2479		CLIENT WILLIAMSON BUILDING CORPORATION	NORTH	$\square$	<b>DA-701</b>	
26 5563	<b>T</b> : +61 2 4926 5563	DRAWING Shadow Diagrams		$\square$	REV	A





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	le <mark>t</mark> he e house	PROJECT DEVELOPMENT APPLICATION	PROJECT #	18065	SCALE @ A1	1:50
arc	hitecture		DRAWN	LS	CHECKED	JK
ASTLE	BYRON BAY Unit 1	ADDRESS 16 GLADYS AVENUE FRENCHS FOREST	DATE	6/12/18	DRAWING No.	
St, e 0	10 Station St, Bangalow NSW 2479	CLIENT WILLIAMSON BUILDING CORPORATION	NORTH	$\square$	DA-702	
26 5563	<b>T</b> : +61 2 4926 5563	DRAWING <b>Solar Analysis</b>		$\square$	REV	A



**PHOTOMONTAGE PERSPECTIVE - STREET VIEW** by BKA Architecture

CHARACTER OF LOCAL AREA: The architecture proposed recognises that boarding housing, notwithstanding is a permissible use for the block, it is a relatively new use within the immediate context, which is merely two and three storey large single dwelling residential. Hence, the buildings comprising the development are domestic in their form and scale. Addressing Gladys Avenue, it is proposed a two-storey element, with a single driveway, an ample balcony and articulated façades that fits perfectly within the residential streetscape. Large trees in the front setback have been retained and protected, and the existing front solid boundary wall has been removed to further naturally integrate the site with the adjacent densely planted suburban context.

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SECTION J EFFICIENT LIVING - Olivia Shortall +61 2 9970 6181 E olivia@efficientliving.com.au	LANDSCAPE ARCHITECT MCLEAN DESIGN - Darrell McLean +61 408 074 967 E df8mclean@gmail.com	FOR DA PURPOSES
CIVIL ENGINEER MARTENS & ASSOCIATES - Gray Taylor +61 2 9476 9999 E gtaylor@martens.com.au	ACOUSTICS NG CHILD & ASSOCIATES - Noel Child +61 2 9899 1968 E ngchild@canda.com	



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ASTLE	BYRON BAY Unit 1	ADDRESS 16 GLADYS AVENUE FRENCHS FOREST	DATE	13/12/18	DRAWING No.	
	10 Station St, Bangalow NSW 2479	CLIENT WILLIAMSON BUILDING CORPORATION	NORTH		<b>DA-800</b>	
26 5563	T: +61 2 4926 5563	DRAWING Photomontage			REV	A



PHOTOMONTAGE PERSPECTIVE - VIEW FROM NORTH-EAST CORNER - 16b GLADYS AVENUE DRIVEWAY (Internal large trees in landscape shown fully grown, 5-6 years) by BKA Architecture

**BULK & SCALE:** The building volumes are distributed along the site following the steep topography. They present a two-story base with a recessed third story level to emphasise its domestic scale. The northern volumes are oriented to maximise solar access and take advantage of the splendid long-distance views. The side elevations of northern volumes are technically 'articulated blind walls' to minimise any overlooking into adjacent properties on 14 & 18 Gladys Avenue. They are setback 2m from side boundaries to allow for deep soil screening planting. The larger than 6m rear setback allows for lush planting and further screening of the proposal from 16a & 16b Gladys Ave dwellings. Existing retained dense screening planting ensures adequate privacy is achieved.

PHOTOMONTAGE PERSPECTIVE - VIEW FROM NORTH-EAST CORNER - 16b GLADYS AVENUE DRIVEWAY (Internal large trees in landscape faded away for clarity purposes, existing screen shrub planting retained) by BKA Architecture








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		ADDRESS				
ASTLE	BYRON BAY Unit 1	16 GLADYS AVENUE FRENCHS FOREST	DATE	13/12/18	DRAWING No.	
n St, e )0	10 Station St, Bangalow NSW 2479	CLIENT WILLIAMSON BUILDING CORPORATION	NORTH		<b>DA-801</b>	
926 5563	<b>T</b> : +61 2 4926 5563	DRAWING Perspectives			REV	A




#### PHOTOMONTAGE PERSPECTIVE - AERIAL VIEW TOWARDS NORTHERN BEACHES HOSPITAL (Indicative massing of proposed Northern Beaches Hospital Precinct Structure Plan new Max Height Limits indicated) by BKA Architecture

**CONTEXTUAL ANALYSIS:** The architecture proposed recognises that boarding housing, notwithstanding is a permissible use for the block, is a relatively new form within the immediate context, which is merely two and three storey large single dwelling residential. Hence, the buildings comprising the development are domestic in their form and scale. The building volumes are distributed along the site following the steep topography. They present a two-story base with a recessed third story level to emphasise its domestic scale. The northern volumes are oriented to maximise solar access and take advantage of the splendid long-distance views. Northern and southern volumes are separated by a couple of large courtyards, breaking the bulk and scale of the development and producing introvert communal areas, away from the side boundaries. These deep soil courtyards also allow for large tree planting within the development.

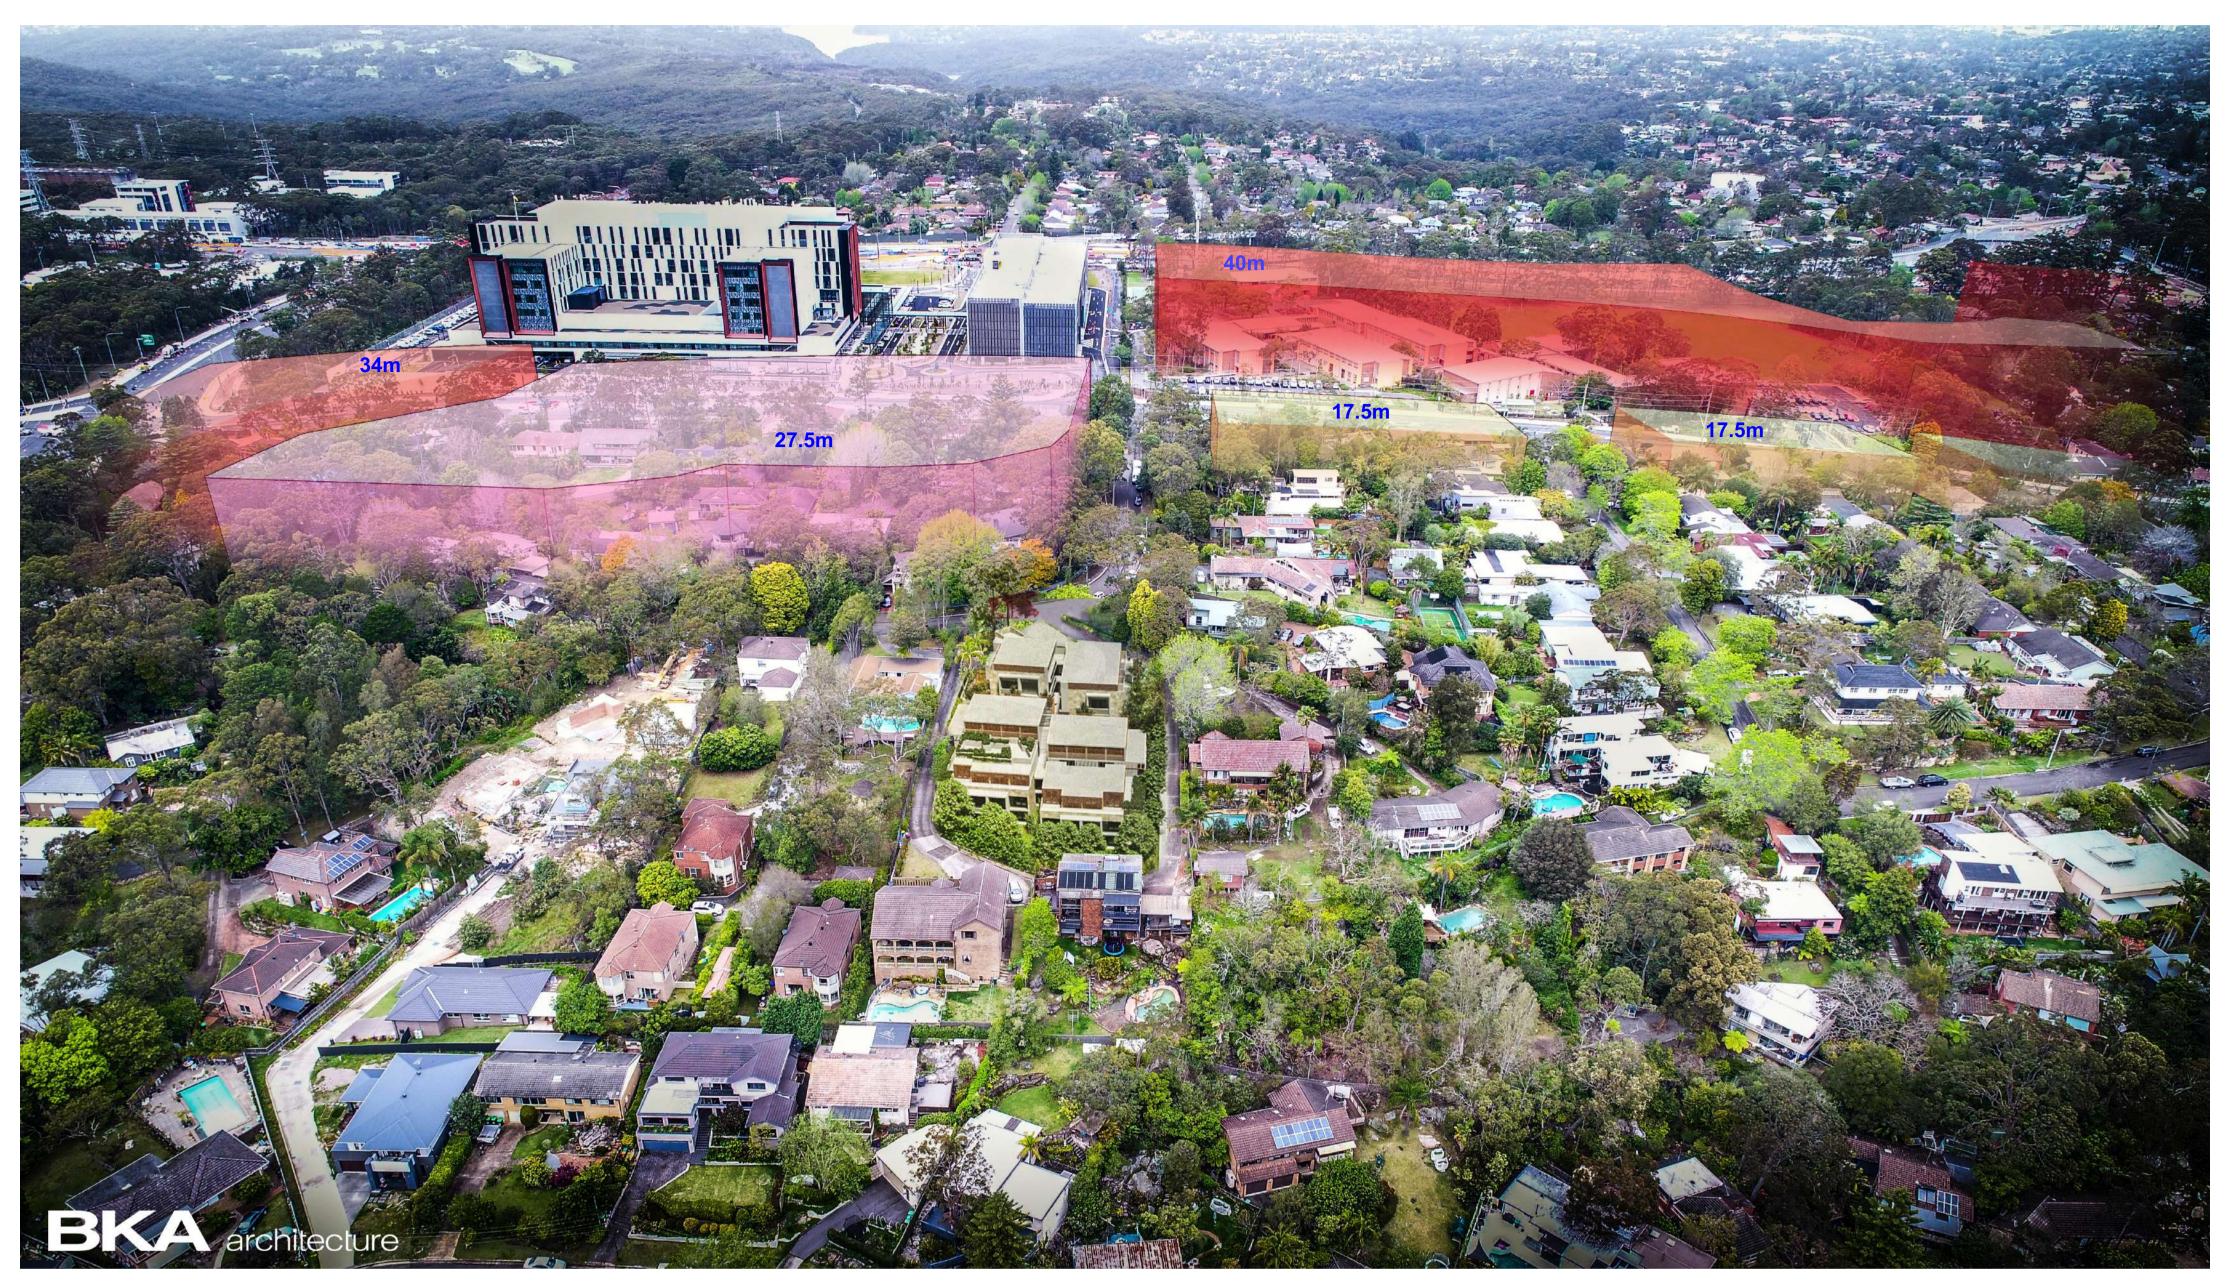The proposed development fits harmoniously within the adjacent context of large dwellings and sits in contrast with the recently opened Northern Beaches Hospital and the scale of future development proposed by Council to be approved in amended LEP for adjacent blocks along Frenchs Forest Rd and southern side of Gladys Ave.


### PHOTOMONTAGE PERSPECTIVE - AERIAL VIEW TOWARDS NORTHERN BEACHES HOSPITAL by BKA Architecture

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		PROJECT DEVELOPMENT APPLICATION	PROJECT #	18065	SCALE @ A1	
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STLE	BYRON BAY Unit 1	ADDRESS 16 GLADYS AVENUE FRENCHS FOREST	DATE	13/12/18	DRAWING No.	
t,	10 Station St, Bangalow NSW 2479	CLIENT WILLIAMSON BUILDING CORPORATION	NORTH		<b>DA-802</b>	
5563	<b>T</b> : +61 2 4926 5563	DRAWING				
		Perspectives			REV	/

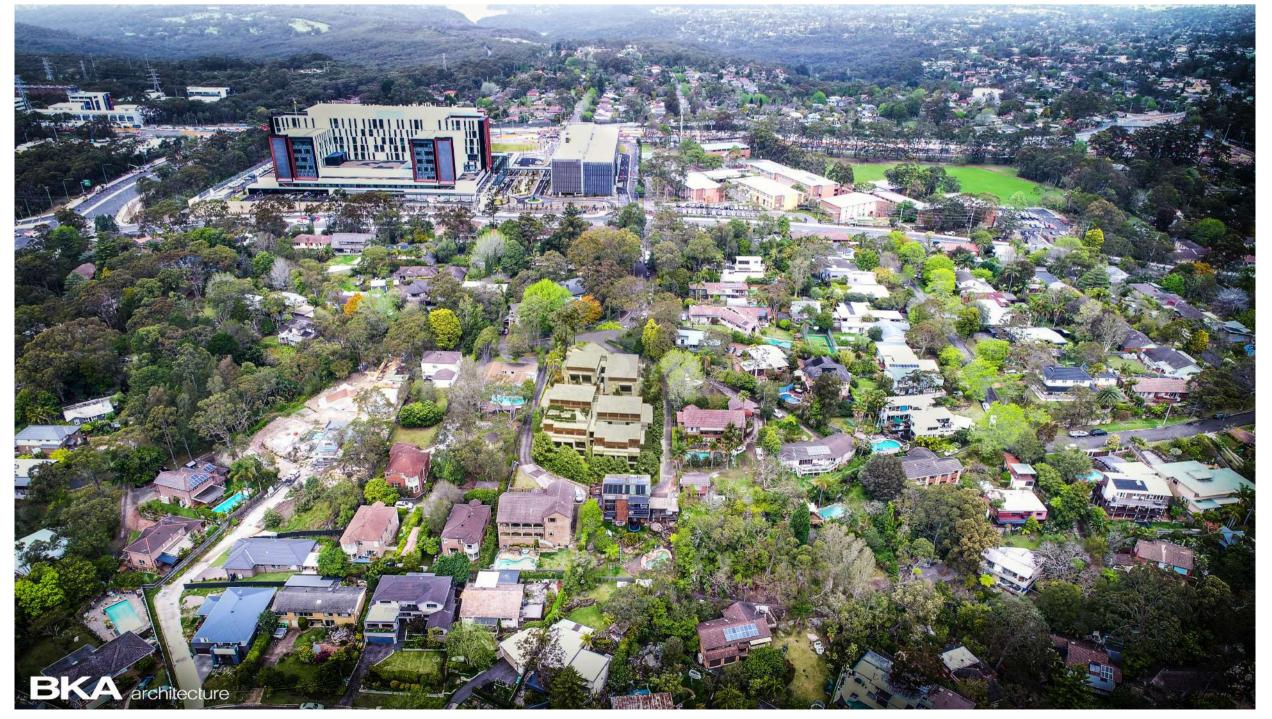

### PERSPECTIVE EAST ELEVATION (Proposed Northern Beaches Hospital Precinct Structure Plan new Max Height Limit indicated) by BKA Architecture

**BULK & SCALE:** The building volumes are distributed along the site following the steep topography. They present a two-story base with a recessed third story level to emphasise its domestic scale. The northern volumes are oriented to maximise solar access and take advantage of the splendid long-distance views. The side elevations of northern to maximise solar access and take advantage of the spiendid long-distance views. The side elevations of northern volumes are technically 'articulated blind walls' to minimise any overlooking into adjacent properties on 14 & 18 Gladys Avenue. They are setback 2m from side boundaries to allow for deep soil screening planting. The larger than 6m rear setback allows for lush planting and further screening of the proposal from 16a & 16b Gladys Ave dwellings. The southern volumes are oriented east-west and incorporate large 6m side setbacks which, plus adding the battle-axe driveways, achieve more than adequate privacy from adjacent dwellings. Northern and southern volumes are separated by a couple of large courtyards, breaking the bulk and scale of the development and producing introvert communal areas, away from the side boundaries. These deep soil courtyards also allow for large tree planting within the development.
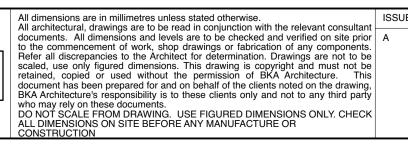
> 16A Gladys Ave.

PERSPECTIVE WEST ELEVATION (Proposed Northern Beaches Hospital Precinct Structure Plan new Max Height Limit indicated) by BKA Architecture

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SECTION J EFFICIENT LIVING - Olivia Shortall +61 2 9970 6181 E olivia@efficientliving.com.au	LANDSCAPE ARCHITECT MCLEAN DESIGN - Darrell McLean +61 408 074 967 E df8mclean@gmail.com	FOR DA PURPOSE
CIVIL ENGINEER MARTENS & ASSOCIATES - Gray Taylor +61 2 9476 9999 E gtaylor@martens.com.au	ACOUSTICS NG CHILD & ASSOCIATES - Noel Child +61 2 9899 1968 E ngchild@canda.com	



**PRIVACY:** The side elevations of northern volumes are technically 'articulated blind walls' to minimise any overlooking into adjacent properties on 14 & 18 Gladys Avenue. They are setback 2m from side boundaries to allow for deep soil screening planting. The end of Level 1 East-West corridors are fitted with timber looking screens to ensure privacy to adjacent dwellings is achieved. Dense screen planting of fast growing Narrow Lilly Pilly trees along side boundary improve even further any privacy issues.





STRUCTION

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### PHOTOMONTAGE PERSPECTIVE FROM 18 GLADYS AVE PRIVATE OPEN SPACE

(Swimming pool) by BKA Architecture. Original photo taken from public submission to DA2017/1433 by Mr Jacob Maurer, owner of 18 Gladys Ave.

		RONBAY 1     ADDRESS 16 GLADYS AVENUE FRENCHS FOREST     DATE     17/12/18     DRAWING No.       1     CLIENT WILLIAMSON BUILDING CORPORATION     NORTH     DAA-803					
arch	hitecture		DRAWN	LS	CHECKED		JK
ASTLE	BYRON BAY Unit 1		DATE	17/12/18	DRAWING No.		
St, e 0	10 Station St, Bangalow NSW 2479		NORTH		<b>DA-8</b>	03	
26 5563	<b>T</b> : +61 2 4926 5563				REV		A



#### **PERSPECTIVE - BIRD'S EYE VIEW OF COMMUNAL OPEN SPACE** by BKA Architecture

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SECTION J <b>EFFICIENT LIVING -</b> Olivia Shortall +61 2 9970 6181 E olivia@efficientliving.com.au	LANDSCAPE ARCHITECT MCLEAN DESIGN - Darrell McLean +61 408 074 967 E df8mclean@gmail.com	FOR DA PURPOSES
CIVIL ENGINEER MARTENS & ASSOCIATES - Gray Taylor +61 2 9476 9999 E gtaylor@martens.com.au	ACOUSTICS NG CHILD & ASSOCIATES - Noel Child +61 2 9899 1968 E ngchild@canda.com	




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STLE	BYRON BAY Unit 1	ADDRESS 16 GLADYS AVENUE FRENCHS FOREST	DATE	13/12/18	DRAWING No.	
St,	10 Station St, Bangalow NSW 2479	CLIENT WILLIAMSON BUILDING CORPORATION	NORTH		<b>DA-804</b>	
5563	<b>T</b> : +61 2 4926 5563	DRAWING Perspectives			REV	A





EXTERNAL WALLS

Domino GR10
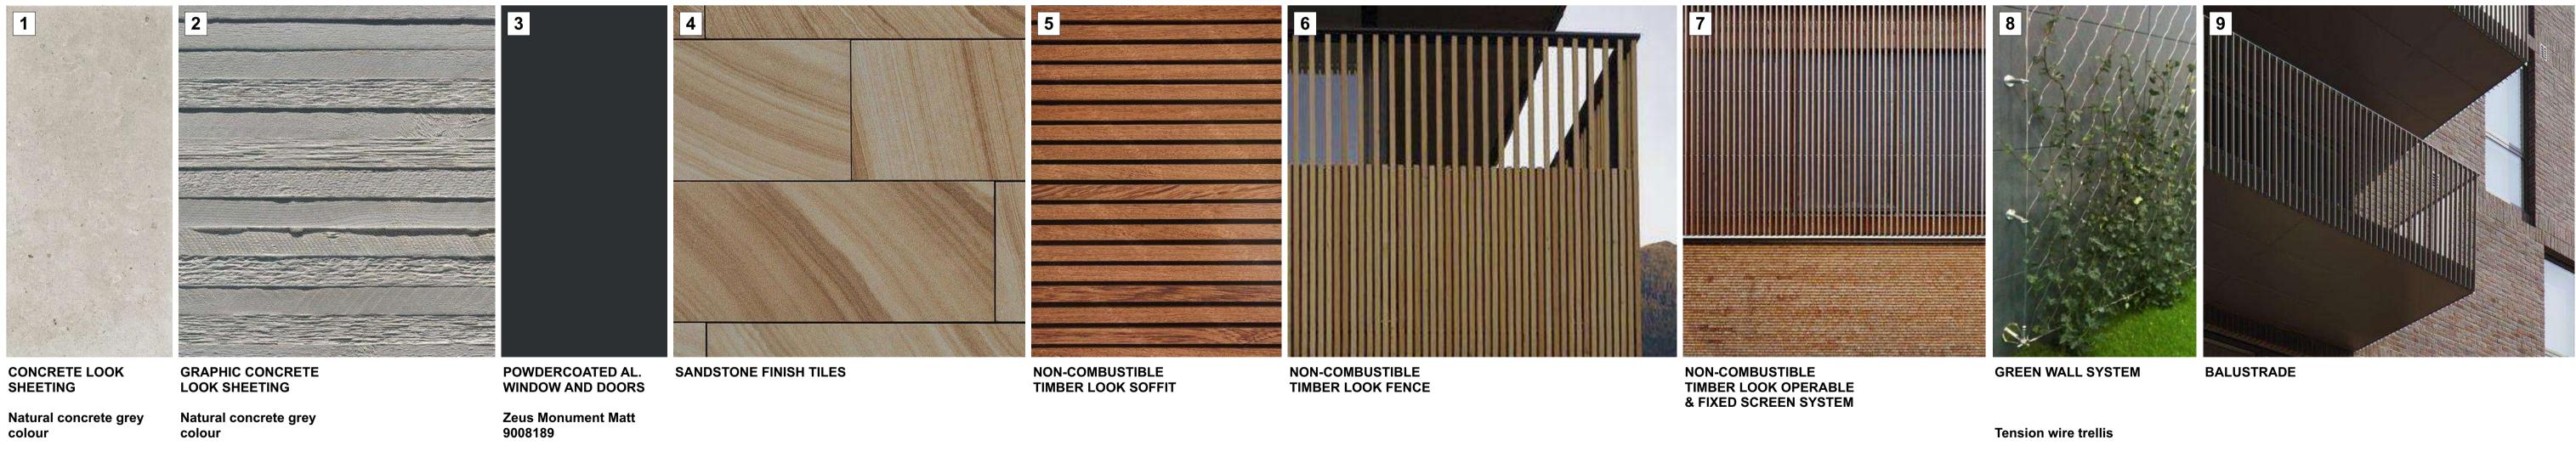
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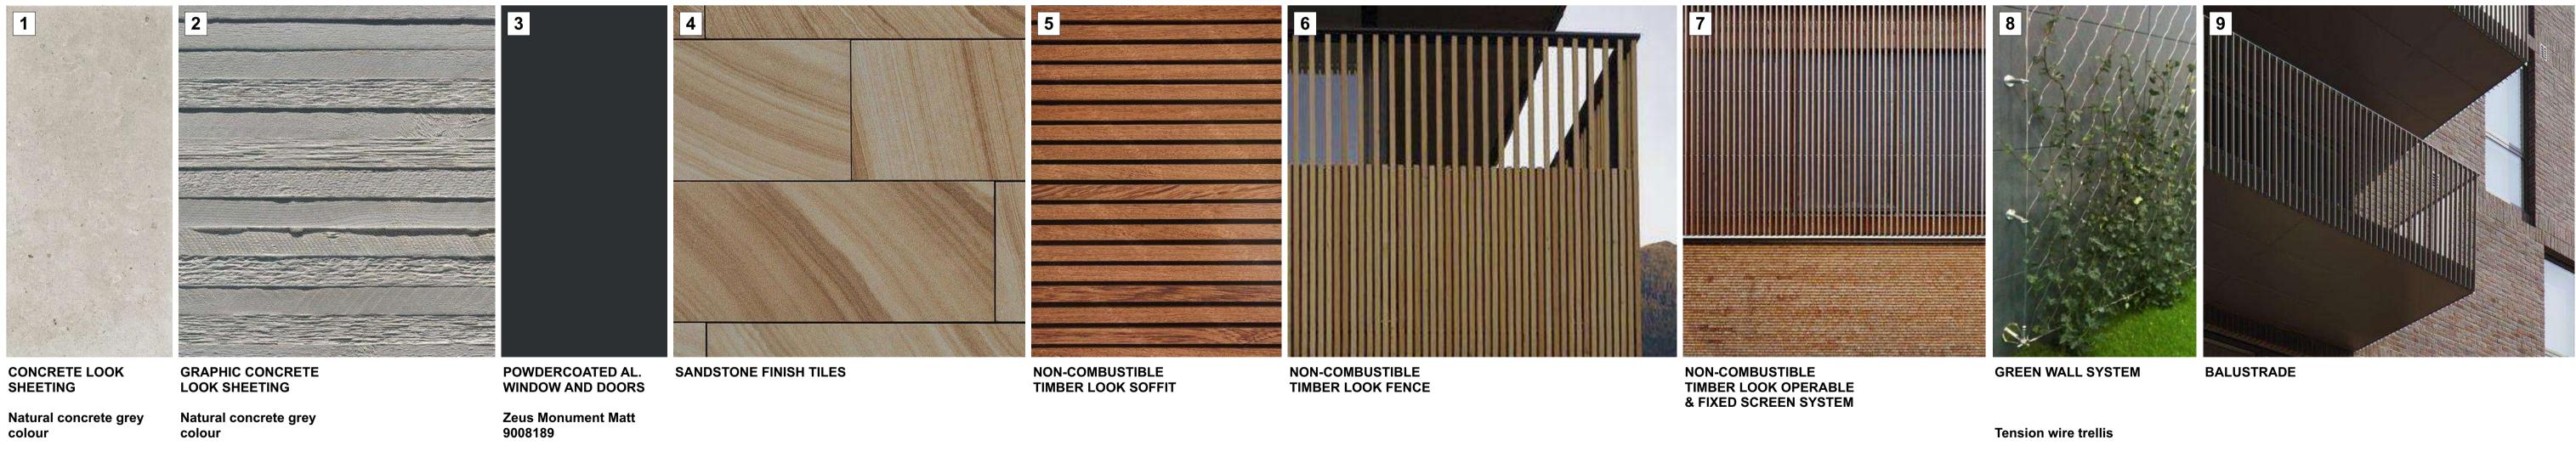


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arc	hitecture	DEVELOPMENT APPLICATION	DRAWN	LS	CHECKED	JK
CASTLE	BYRON BAY Unit 1	ADDRESS 16 GLADYS AVENUE FRENCHS FOREST	DATE	6/12/18	DRAWING No.	
n St, tle 600	10 Station St, Bangalow NSW 2479	CLIENT WILLIAMSON BUILDING CORPORATION	NORTH		<b>DA-9</b>	00
926 5563	<b>T</b> : +61 2 4926 5563	DRAWING Schedule of Materials nd Finishes			REV	A





EXTERNAL WALLS

Domino GR10

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			PROJECT #	18065	SCALE @ A1	1:100
arc	hitecture	DEVELOPMENT APPLICATION	DRAWN	LS	CHECKED	JK
CASTLE	BYRON BAY Unit 1	ADDRESS 16 GLADYS AVENUE FRENCHS FOREST	DATE	6/12/18	DRAWING No.	
n St, tle 600	10 Station St, Bangalow NSW 2479	CLIENT WILLIAMSON BUILDING CORPORATION	NORTH		<b>DA-9</b>	00
926 5563	<b>T</b> : +61 2 4926 5563	DRAWING Schedule of Materials nd Finishes			REV	A

## mclean design

landscape architecture | masterplanning | urban design

Darrell McLean AILA / RLA Registered Landscape Architect


M: 0408 074 967 E: df8mclean@gmail.com


### LANDSCAPE DA SUBMISSION

### 16 GLADYS AVENUE, FRENCHS FOREST NSW 2086

#### LANDSCAPE DRAWING SCHEDULE


DWG. NO.	TITLE	SCALE	REV.	DATE
P01813 - 01	LANDSCAPE GENERAL ARRANGEMENT PLAN	1:200		23.11.18
P01813 - 02	LANDSCAPE GRADING PLAN	1:200		23.11.18
P01813 - 03	LANDSCAPE PLANTING PLAN	1:200		23.11.18
P01813 - 04	LANDSCAPE ROOF GARDEN PLAN	1:200		23.11.18
P01813 - 05	TYPICAL LOWER COURTYARD PLAN	1:50		23.11.18
P01813 - 06	PLANT MATERIAL SCHEDULE & IMAGES	N/A		23.11.18
P01813 - 07	LANDSCAPE DETAILS	AS SHOWN	l	23.11.18
P01813 - 08	LANDSCAPE CHARACTER IMAGES	N/A		23.11.18
P01813 - 09	LANDSCAPE CHARACTER IMAGES	N/A		23.11.18

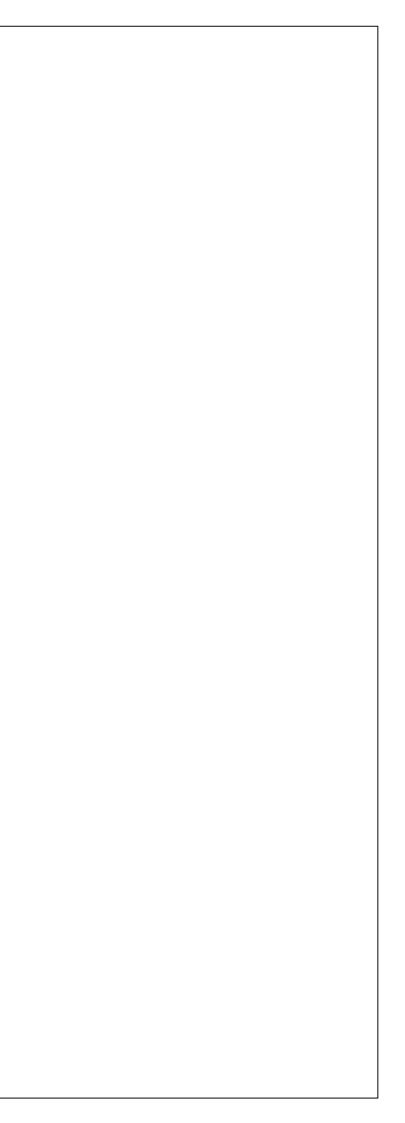

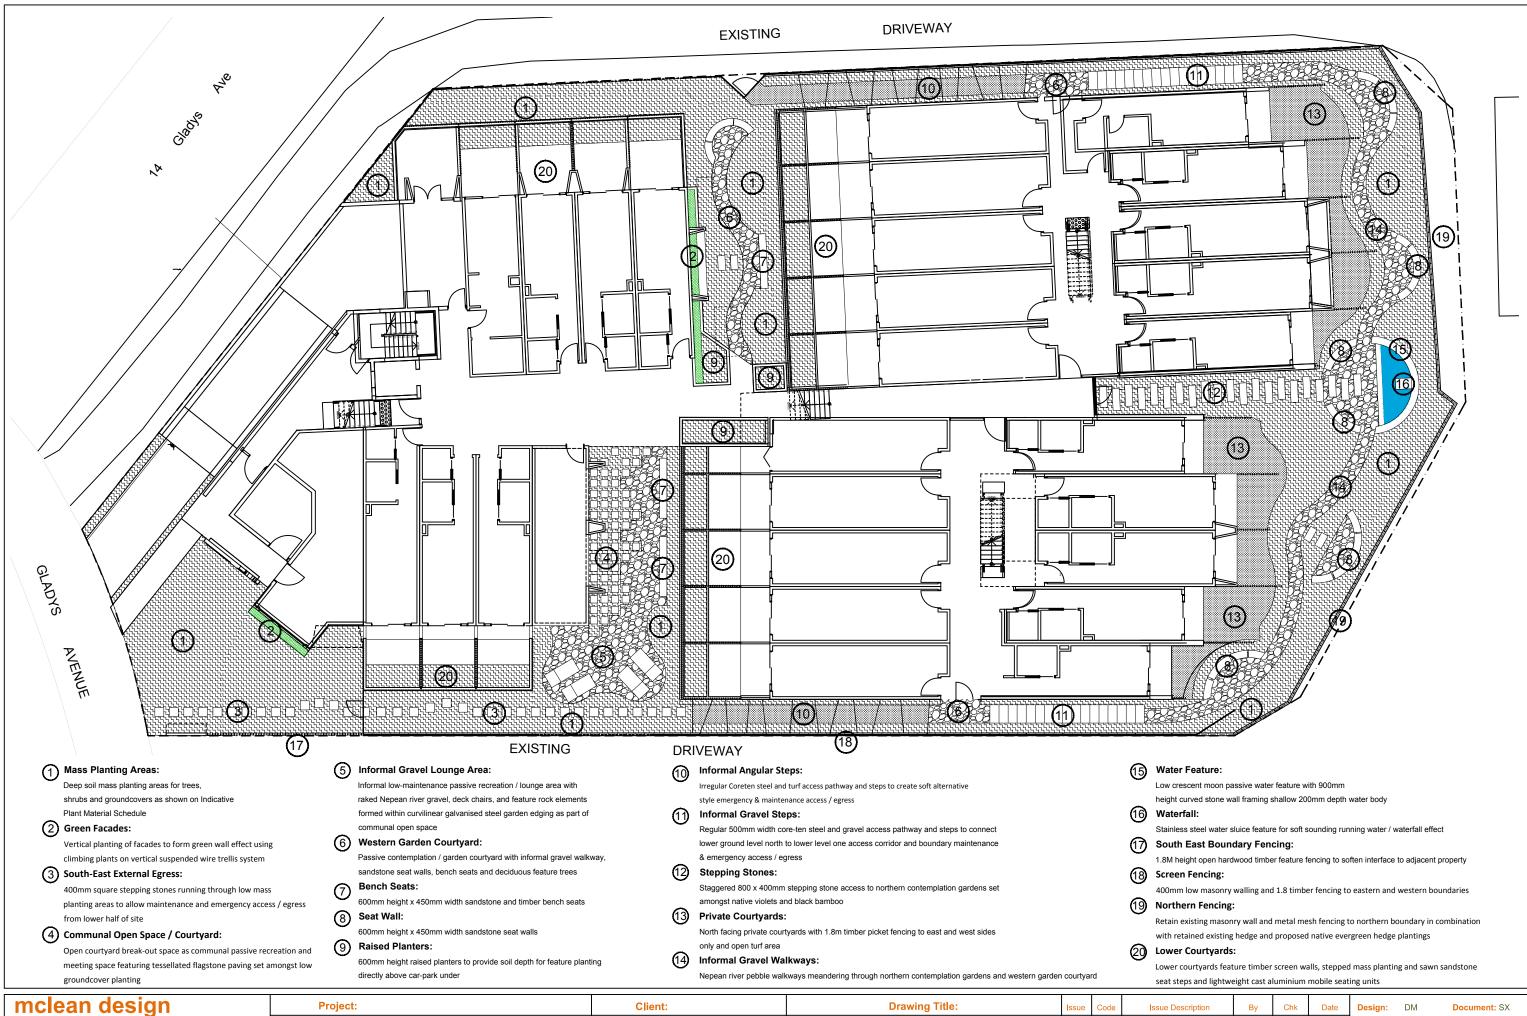

Inclean design	Project.	Client:	Drawing The:	Issue	Code	
landscape architecture   masterplanning   urban design Registered Landscape Architect Darrell McLean RLA No. 076 113 Woorarra Avenue Elanora Heights NSW 2101 Ph: 0408074967   Em: <u>dt8mclean@gmail.com</u>   ABN: 20 624 134 836	16 Gladys Ave, Frenchs Forest, NSW 2086 Australia		Landscape Arrangement Plan			


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DA ISSUE	DMc	DMc	23.11.18	Project No: P01813 Date: 23.11.18
				Scale:         1:200 @ A3           Drawing Number:         Rev:           P01813-01

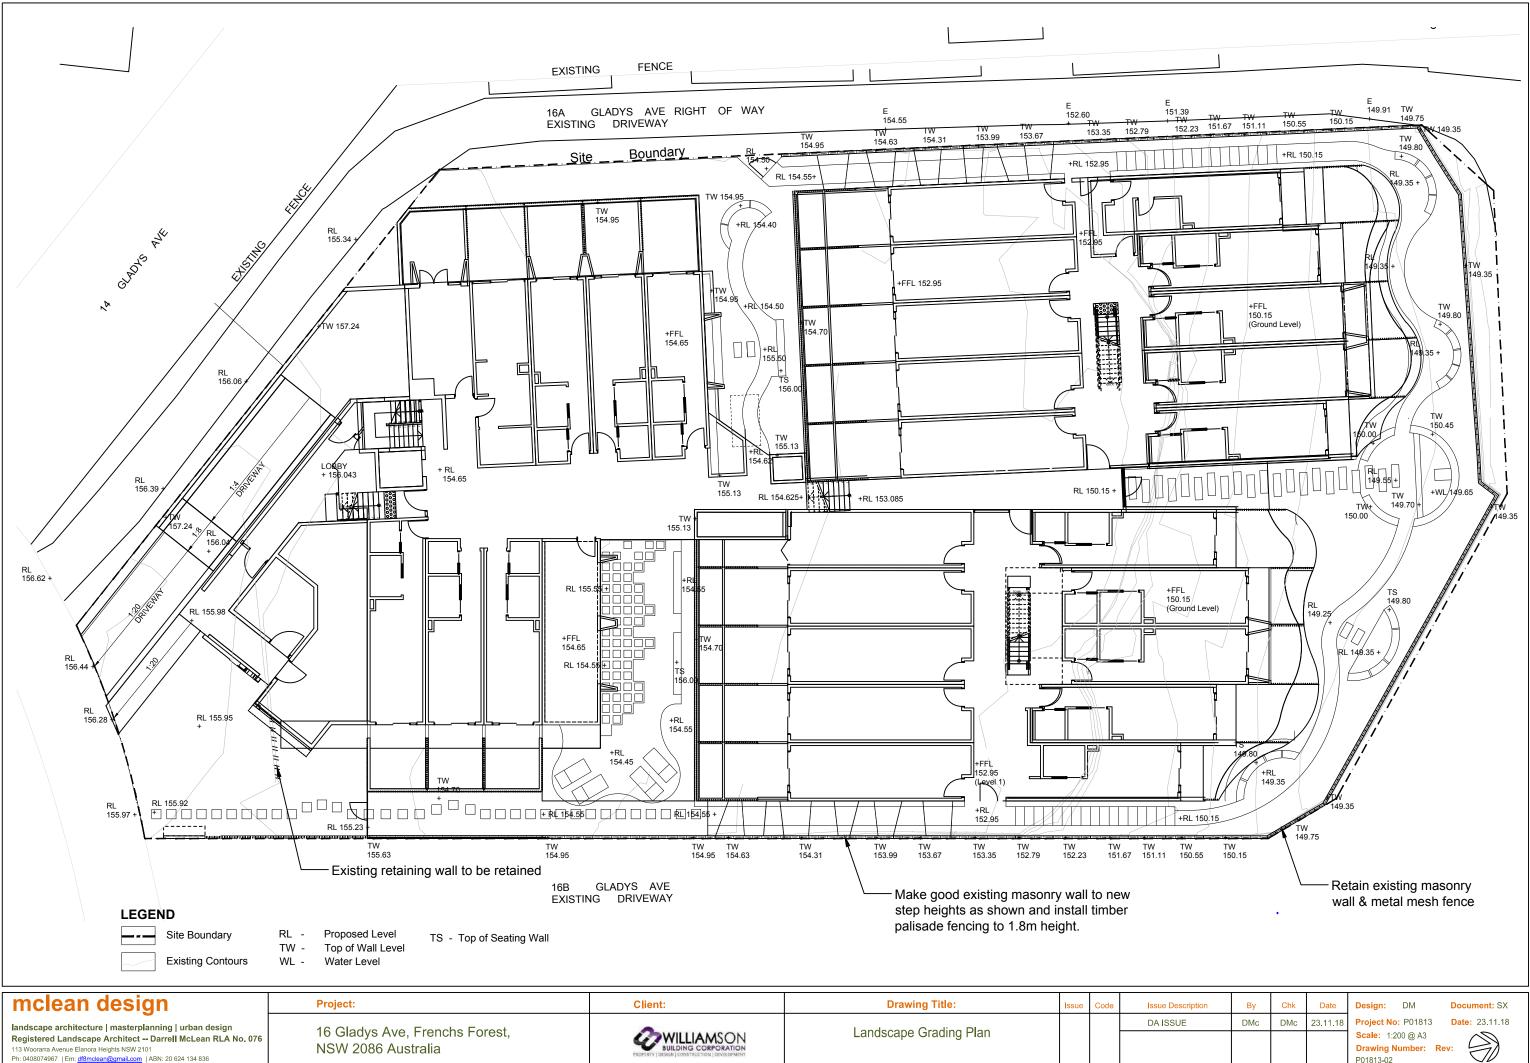



Registereu Lanuscape Architect - Darreit wollean Ri
113 Woorarra Avenue Elanora Heights NSW 2101
Pb: 0408074967   Em: df8mcloop@gmoil.com   ARN: 20.624.134.836

Landscape Grading Plan

P01813-02

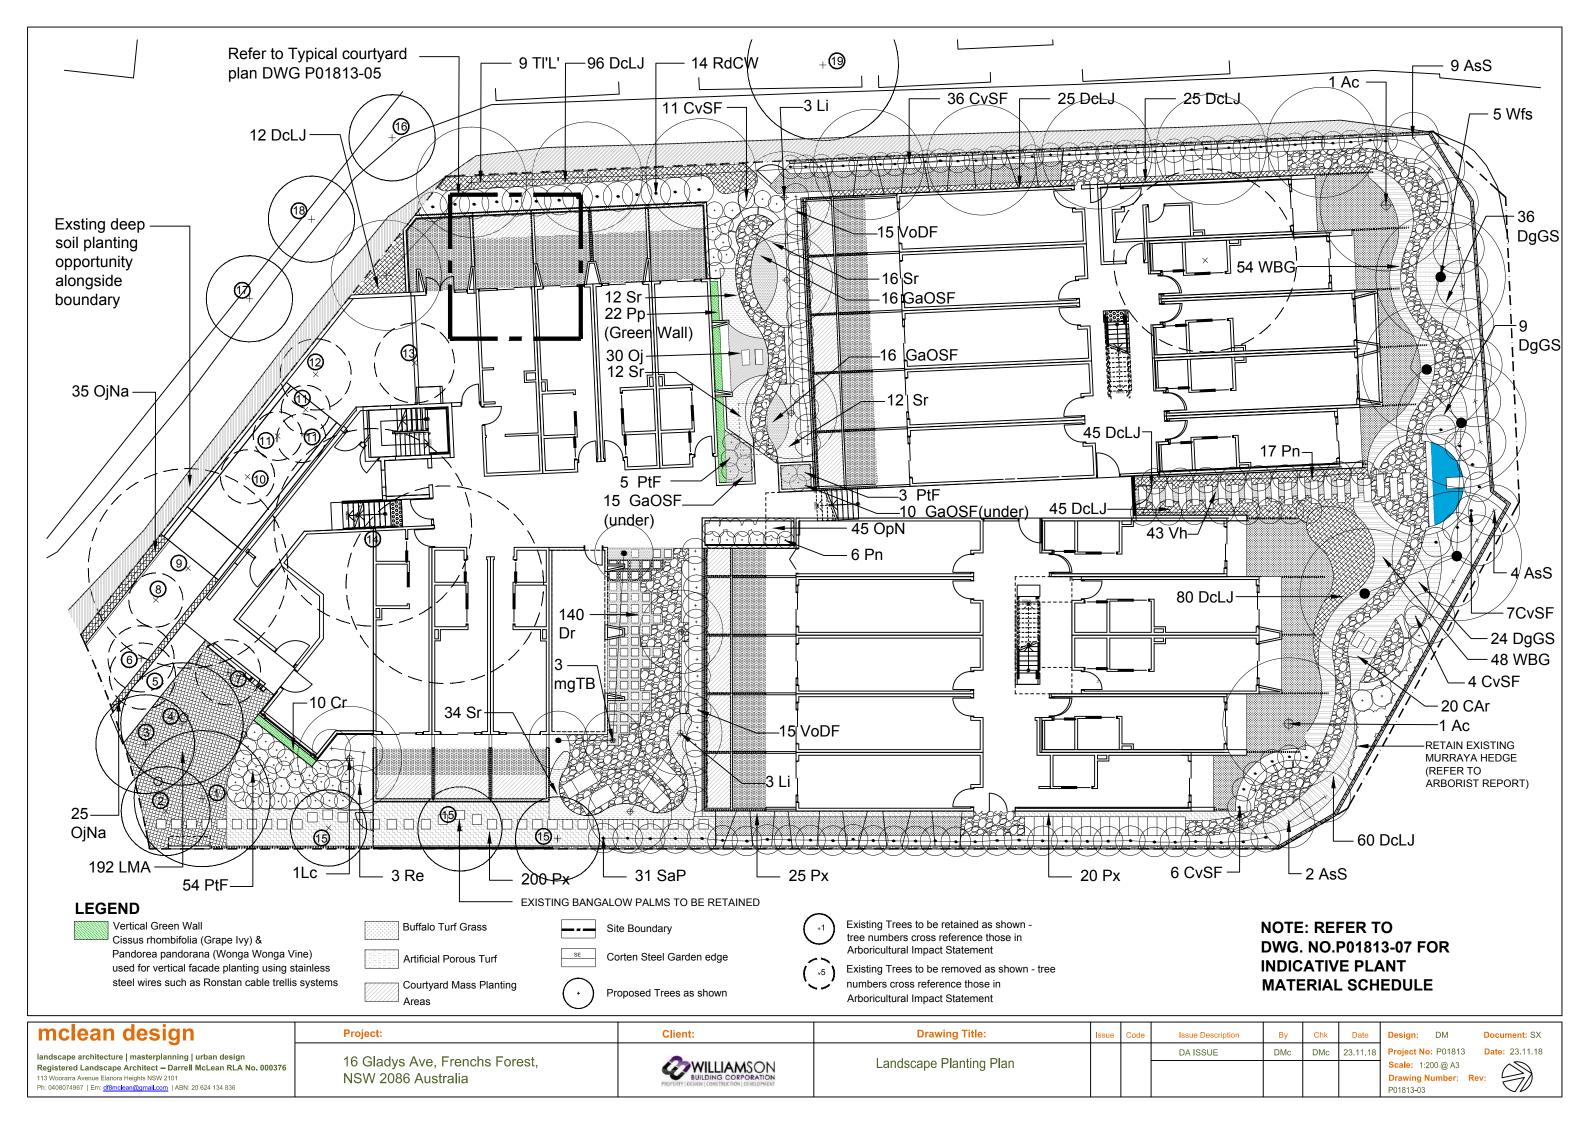

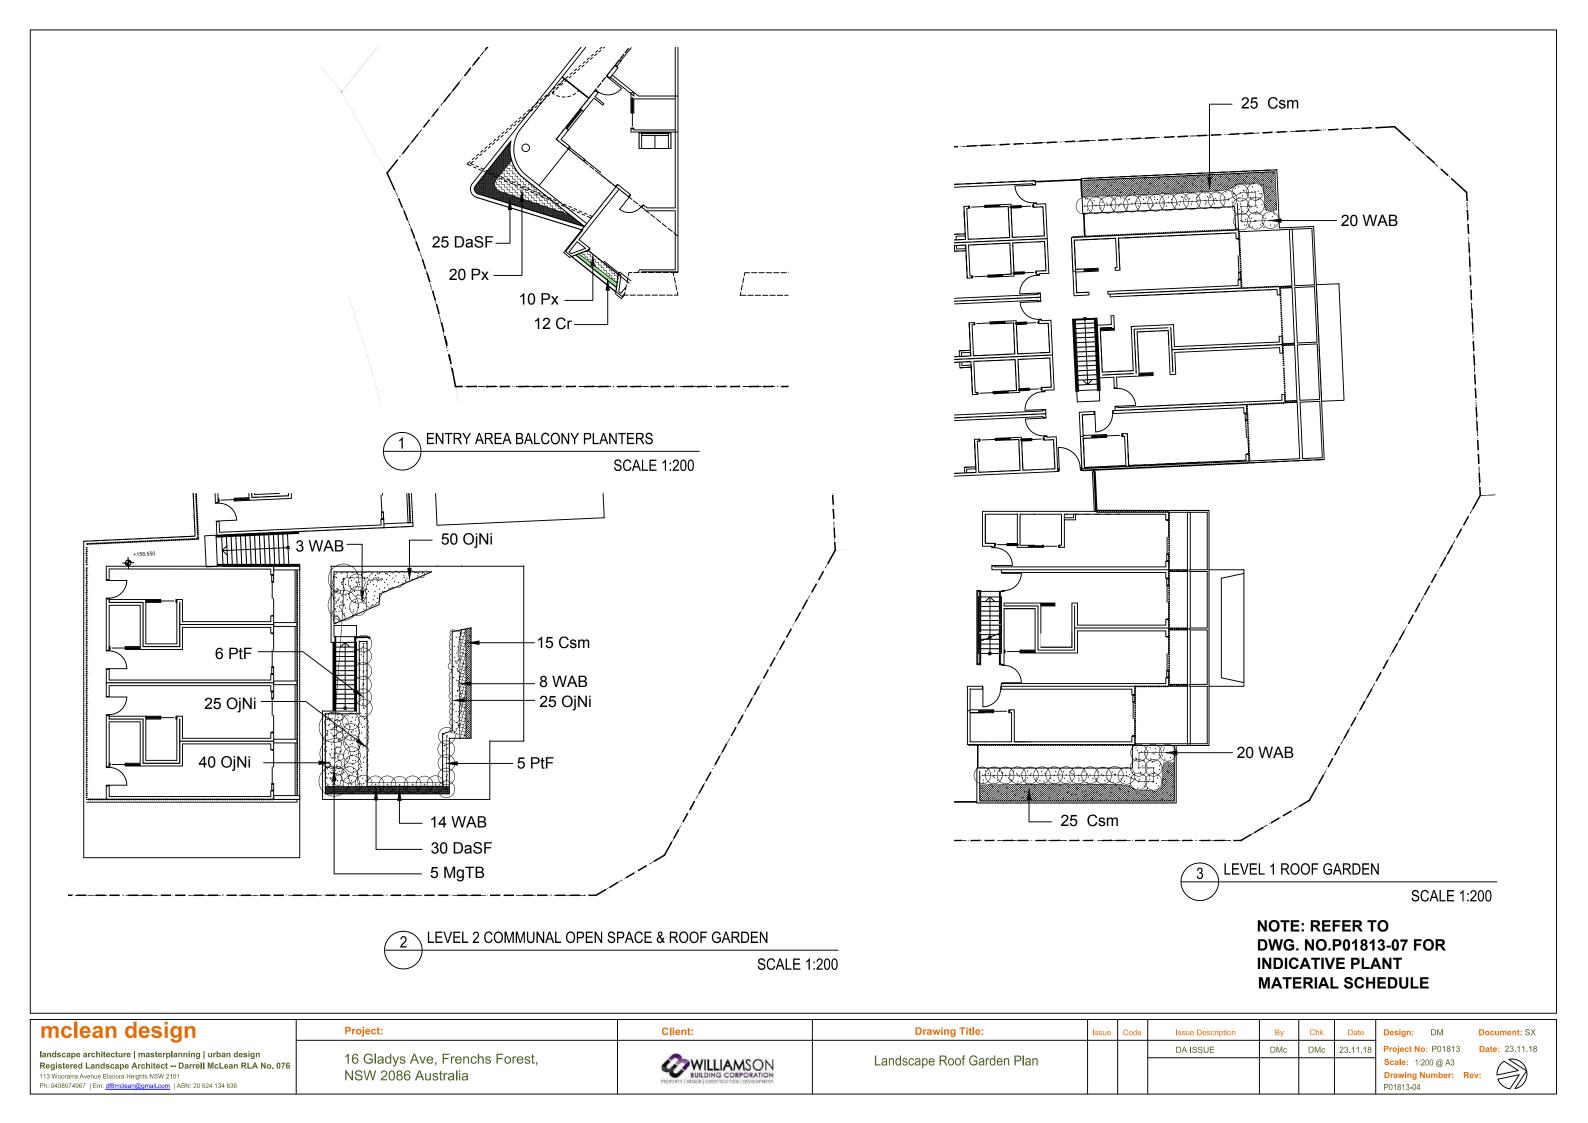

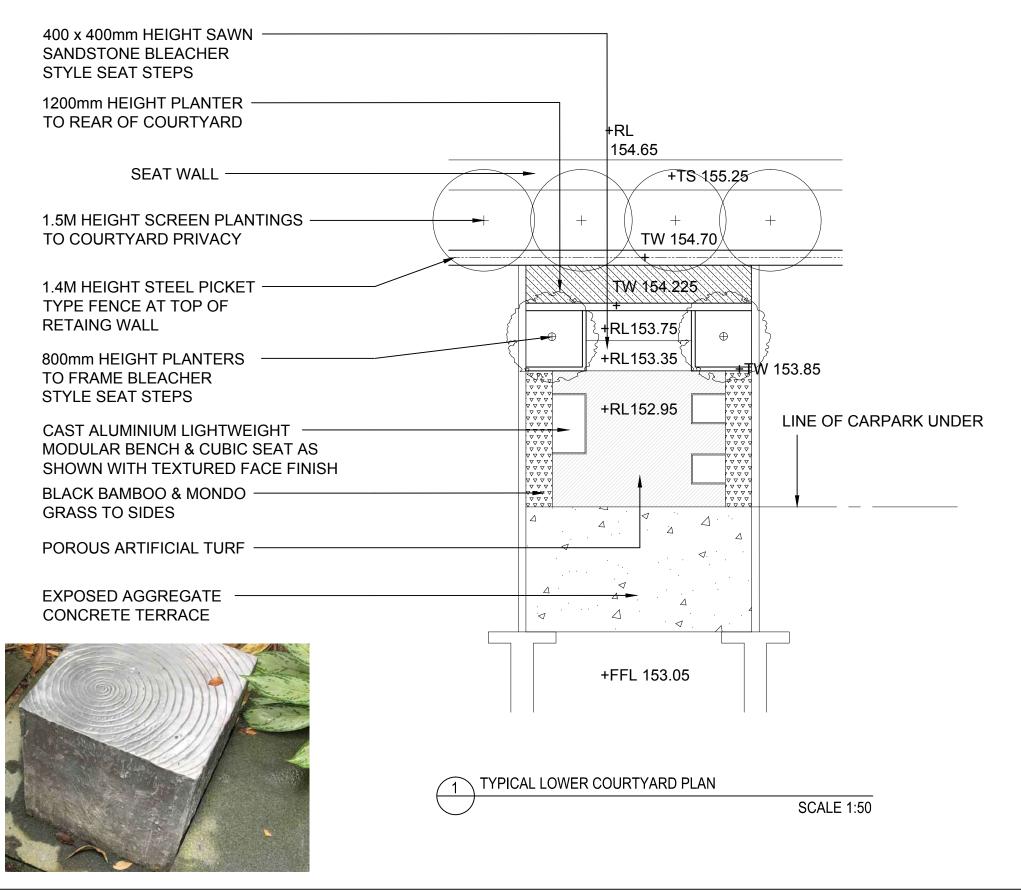

mclean design	Project:	Client:	Drawing Title:	Issue Code	Issue Description	Ву	Chk	Date	Design: DM	Document: SX
Iandscape architecture   masterplanning   urban design Registered Landscape Architect Darrell McLean RLA No. 076 113 Woorarra Avenue Elanora Heights NSW 2101 Ph: 0408074967   Em: <u>dtBmclean@gmail.com</u>   ABN: 20 624 134 836	16 Gladys Ave, Frenchs Forest, NSW 2086 Australia		Typical Lower Courtyard Plan	-	DA ISSUE	DMc	DMc	23.11.18	Project No: P01813 Scale: AS SHOWN Drawing Number: R P01813-05	Date: 23.11.18



		PLAN CODE	ANT MATERIA	* SUPPLIER PATENT	NUMADED	CRACING	ULICHT	SPREAD	ULICHT	CODEAD	POT SIZE
BOTANICAL NAME	COMINION NAME	PLAN CODE	IMAGE REFERENCE	* SUPPLIER PATENT	NUMBER	SPACING			HEIGHT		PO1 5120
DEEC D DALBAC		1	1			3	AIPD	NTING	ATWA	TURITY	
IREES & PALMS	COLOR DOLLAR	Acc	1	0014/20	16	- /	2.014	1 214	FOM	2.5m	1001
Acmena smithii 'Sublime'	Lilly Pilly	AsS	1	DOW30	15	n/a	2.0M	1.2M	5.0M	2.5m	100L
Angophora costata	Smooth Barked Apple	Ac	2		2	n/a	2.0M	1.2M	15.0M	5.0M	75L
agerstroemia indica	Crepe Myrtle	Li	3		6	n/a	2.0M	2.0M	4.0M	4.0M	100L
ivistona chinensis	Cabbage Palm	Lc	4		1	n/a	4.0M	2.0M	8.0M	5.0M	400L
Magnolia grandiflora 'Teddy Bear'	Dwarf Magnolia	MgTB	5	A A T C	8	n/a	1.6M	0.8m	3.0M	2.0M	100L
yzygium australe 'Pinnacle'	Narrow Lilly Pilly	SaP	6	AATS	31	1.2M	1.0M	0.3M	8.0M	1.5M	800L
Fristaniopsis laurina 'Luscious'	Water Gum	TIL	7	DOW10	9	n/a	2.0M	1.6M	8.0M	5.0M	75L
Naterhousea floribunda 'Sweeper'	Weeping Lilly Pilly	WfS	8	DOW20	5	n/a	2.0M	1.6M	10.0M	5.0M	100L
SHRUBS								200-100-01-01	-		
Callistemon viminalis 'Scarlet Flame''	Dwarf Bottle Brush	CvSF	9	CC19	58	0.5M	0.6M	0.4M	1.4M	1.0M	200mm
Phyllostachys nigra	Black Bamboo	Pn	10		23	0.5M	0.6M	0.4M	2.0M	0.6M	15L
Phormium tenax 'Flamin'	Dwarf Cordyline	PtF	11	PHOS3	73	0.4M	0.5M	0.4M	1.0M	0.6M	200MM
Raphis excelsa	Lady Palm	Re	12		3	1.5M	1.4M	0.8M	2.0M	2.0M	25L
Rhaphiolepsis delacourii 'Cosmic White'	Indian Hawthorn	RdCW	13	RAPH01	14	1.0M	0.45M	0.45M	1.5M	1.5M	200mm
Strelitzea reginae	Bird of Paradise	Sr	14		86	0.5M	0.4M	0.4M	1.0M	0.75M	150mm
/iburnum odoratissimum 'Dense Fence'	Dwarf Sweet Viburnum	VoDF	15	VOC1	30	1.2M	1.0M	0.3M	2.5M	1.8M	200mm
Westringia 'Aussie Box'	Dwarf Coastal Rosemary	WAB	16	WESO2	65	0.5M	0.4M	0.4M	1.5M	1.3M	200mm
Westringia 'Blue Gem'	Coastal Rosemary	WGB	17	WESO3	102	0.5M	0.4M	0.4M	1.5M	1.3M	200mm
GROUNDCOVERS											
Carpobrotus glauscens 'Aussie Rambler'	Pigface	CAR	18	CAR10	20	6/m2	n/a	n/a	n/a	n/a	100mm
Dichondra repens	Kidney Weed	Dr	19		140	10/m2	n/a	n/a	n/a	n/a	100mm
Gardenia augusta 'Radicans' 'O So Fine'	Dwarf Gardenia	GaOSF	20	KEN04	77	6/m2	n/a	n/a	n/a	n/a	100mm
Ophiopogon japonicus	Mondo Grass	Oj	21		30	6/m2	n/a	n/a	n/a	n/a	100mm
Ophiopogon japonicus 'Nana'	Dwarf Mondo Grass	OjNa	22		60	6/m3	n/a	n/a	n/a	n/a	100mm
Ophiopogon planiscarpus 'Nigrescens'	Black Mondo Grass	OjNi	23		185	6/m2	n/a	n/a	n/a	n/a	100mm
Philodendron 'Xanadu'	Dwarf Philodendron	Px	24		275	6/m2	n/a	n/a	n/a	n/a	100mm
/iola hederacea	Native Violet	Vh	25	1	43	6/m2	n/a	n/a	n/a	n/a	100mm
/ERTICAL GREEN WALL & BALCONY CLIMBERS	& TRAILERS	(1.11)						10.0			
Cissus rhombifolia	Grape Ivy	Cr	26		10	6/m2	n/a	n/a	n/a	n/a	100mm
Convolvulus sabatius 'Mauritanicus'	Blue Rock Bindweed	CsM	27		85	6/m2	n/a	n/a	n/a	n/a	100mm
Dichondra argentea	Silver Falls	DaSF	28		55	6/m2	n/a	n/a	n/a	n/a	100mm
NATIVE GRASSES & LILLIES	Silver Fund					0,1112		n/ u		11/4	1001111
Dianella caerulae 'Little Jess'	Dwarf Dianella	DcLJ	29	DCMP01	320	8/m2	n/a	n/a	n/a	n/a	100mm
Dietes grandiflora 'Grand Star'	Dwarf Wild Iris	-	30	Dil	69	4/m2	n/a	n/a	n/a	n/a	100mm
		DgGS	31	LIRTP							2020/06/2020/2020
iriope muscari 'Just Amaethyst''	Turf Lilly	LMA	21	LIKTP	192	6/m1	n/a	n/a	n/a	n/a	100mm
DRNAMENTAL POTS							0.614	0.011	4 5 1 4	1.011	4000
Alcantarea imperialis 'Rubra'	Giant Bromeliad	n/a	32		tbc	n/a	0.8M	0.6M	1.5M	1.0M	100L














mclean design	Project:	Client:	Drawing Title:	Issue Code	Issue Description	Ву	Chk Date	Design: DM Document: SX
landscape architecture   masterplanning   urban design Registered Landscape Architect Darrell McLean RLA No. 076 113 Woorarra Avenue Elanora Heights NSW 2101 Ph: 0408074967   Em: <u>df8mdean@gmail.com</u>   ABN: 20 624 134 836	16 Gladys Ave, Frenchs Forest, NSW 2086 Australia		Plant Material Schedule & Images		DA ISSUE	DMc	DMc 23.11.18	Project No:         P01813         Date:         23.11.18           Scale:         N/A         Drawing Number:         Rev:           P01813-06         P01813-06         P01813-06         P01813-06





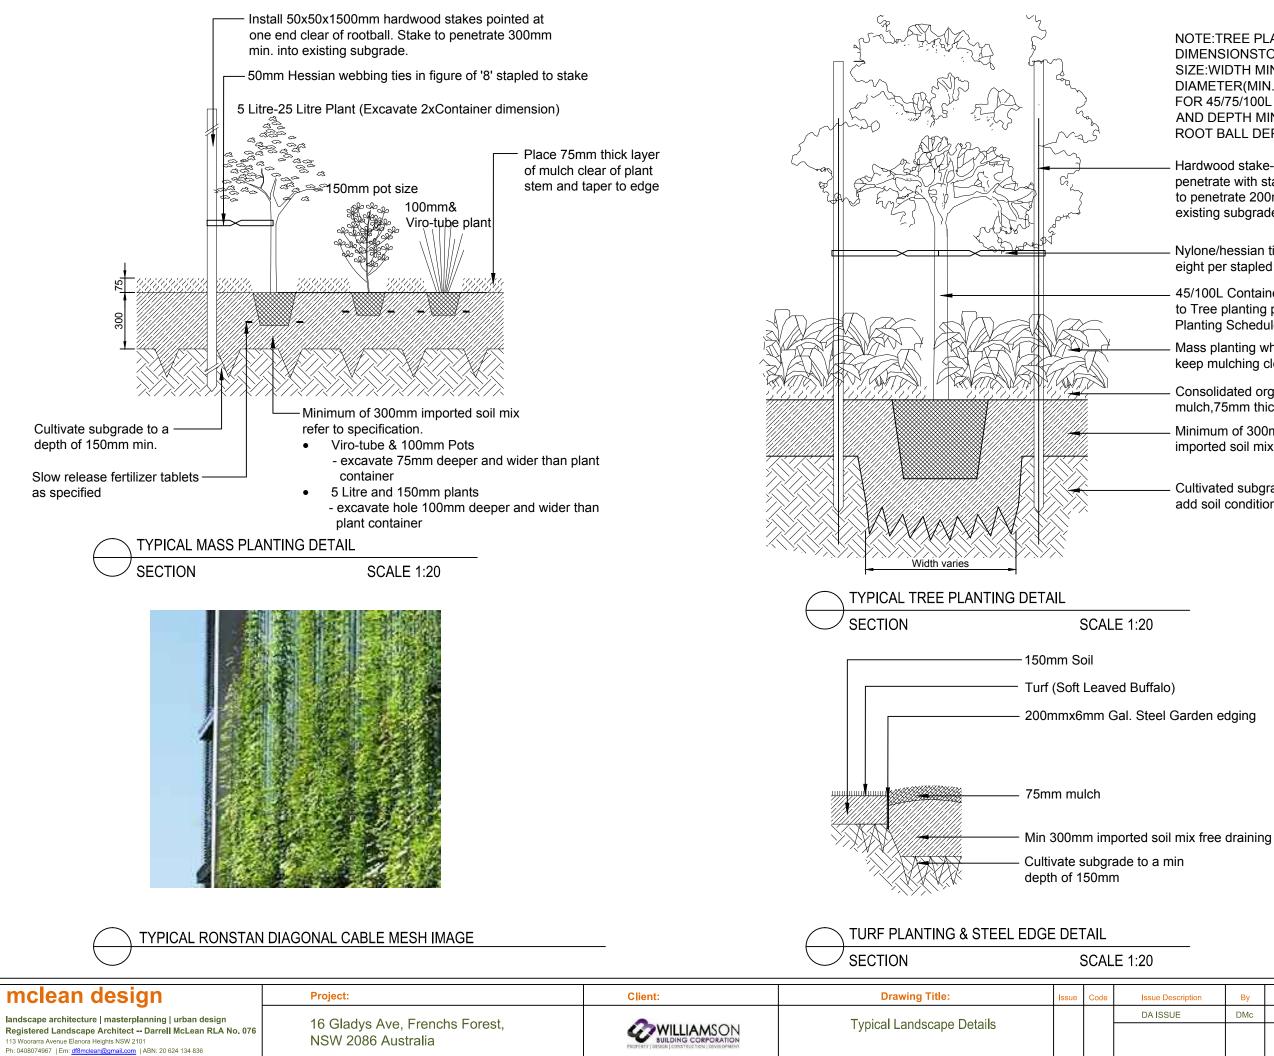


NOTE: TREE PLANTING HOLE DIMENSIONSTO CONTAINER SIZE:WIDTH MIN.3X ROOTBALL DIAMETER(MIN.820/1100/1400MM FOR 45/75/100L CONTAINERS) AND DEPTH MIN.150MM BELOW ROOT BALL DEPTH.

- Hardwood stake-do not penetrate with stake. stake to penetrate 200mm into existing subgrade
- Nylone/hessian tie with figure eight per stapled to stake
- 45/100L Container tree refer to Tree planting plans and Planting Schedule
- Mass planting where shown in plan. keep mulching clear of plant sterm.
- Consolidated organic mulch,75mm thick
- Minimum of 300mm imported soil mix
- Cultivated subgrade 150mm depth, add soil conditioners as specified.

Description	Ву	Chk	Date	Design: DM Document:	sx
SSUE	DMc	DMc	23.11.18	Project No: P01813 Date: 23.1	1.18
				Scale: AS SHOWN	
				Drawing Number: Rev:	
				P01813-07	





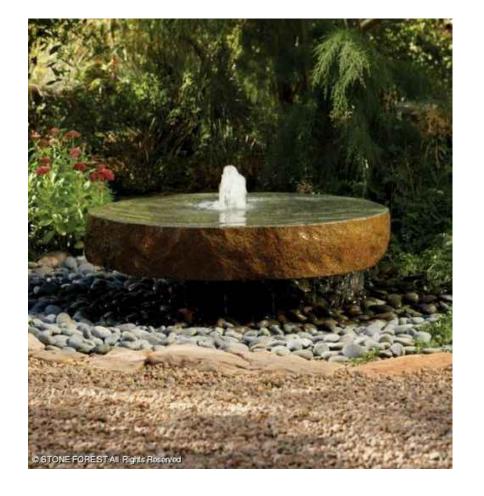





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Iandscape architecture | masterplanning | urban design Registered Landscape Architect – Darrell McLean RLA No. 076 113 Woorarra Avenue Elanora Heights NSW 2101 Ph: 0408074967 | Em: <u>dtBmclean@gmail.com</u> | ABN: 20 624 134 836 16 Gladys Ave, Frenchs Forest, NSW 2086 Australia

Project:



Drawing Title:

Landscape Character Images

Code Issue D DA ISS



Description	Ву	Chk	Date	Design:	DM	Document: SX
SSUE	DMc	DMc	23.11.18	Project No	: P01813	Date: 23.11.18
				Scale: AS	SHOWN	
				Drawing N	umber: Re	ev:
				P01813-08		



mclean design	Project:	Client:	Drawing Title:	Issue	Code	Issue Description	Ву	Chk	Date	Design: DM	Document: SX
Iandscape architecture   masterplanning   urban design Registered Landscape Architect – Darrell McLean RLA No. 076 113 Woorarra Avenue Elanora Heights NSW 2101 Ph: 0408074967   Em: <u>df8mclean@gmail.com</u>   ABN: 20 624 134 836	16 Gladys Ave, Frenchs Forest, NSW 2086 Australia		Landscape Character Images			DA ISSUE	DMc	DMc	23.11.18	Project No: P01813 Scale: AS SHOWN Drawing Number: R P01813-09	

